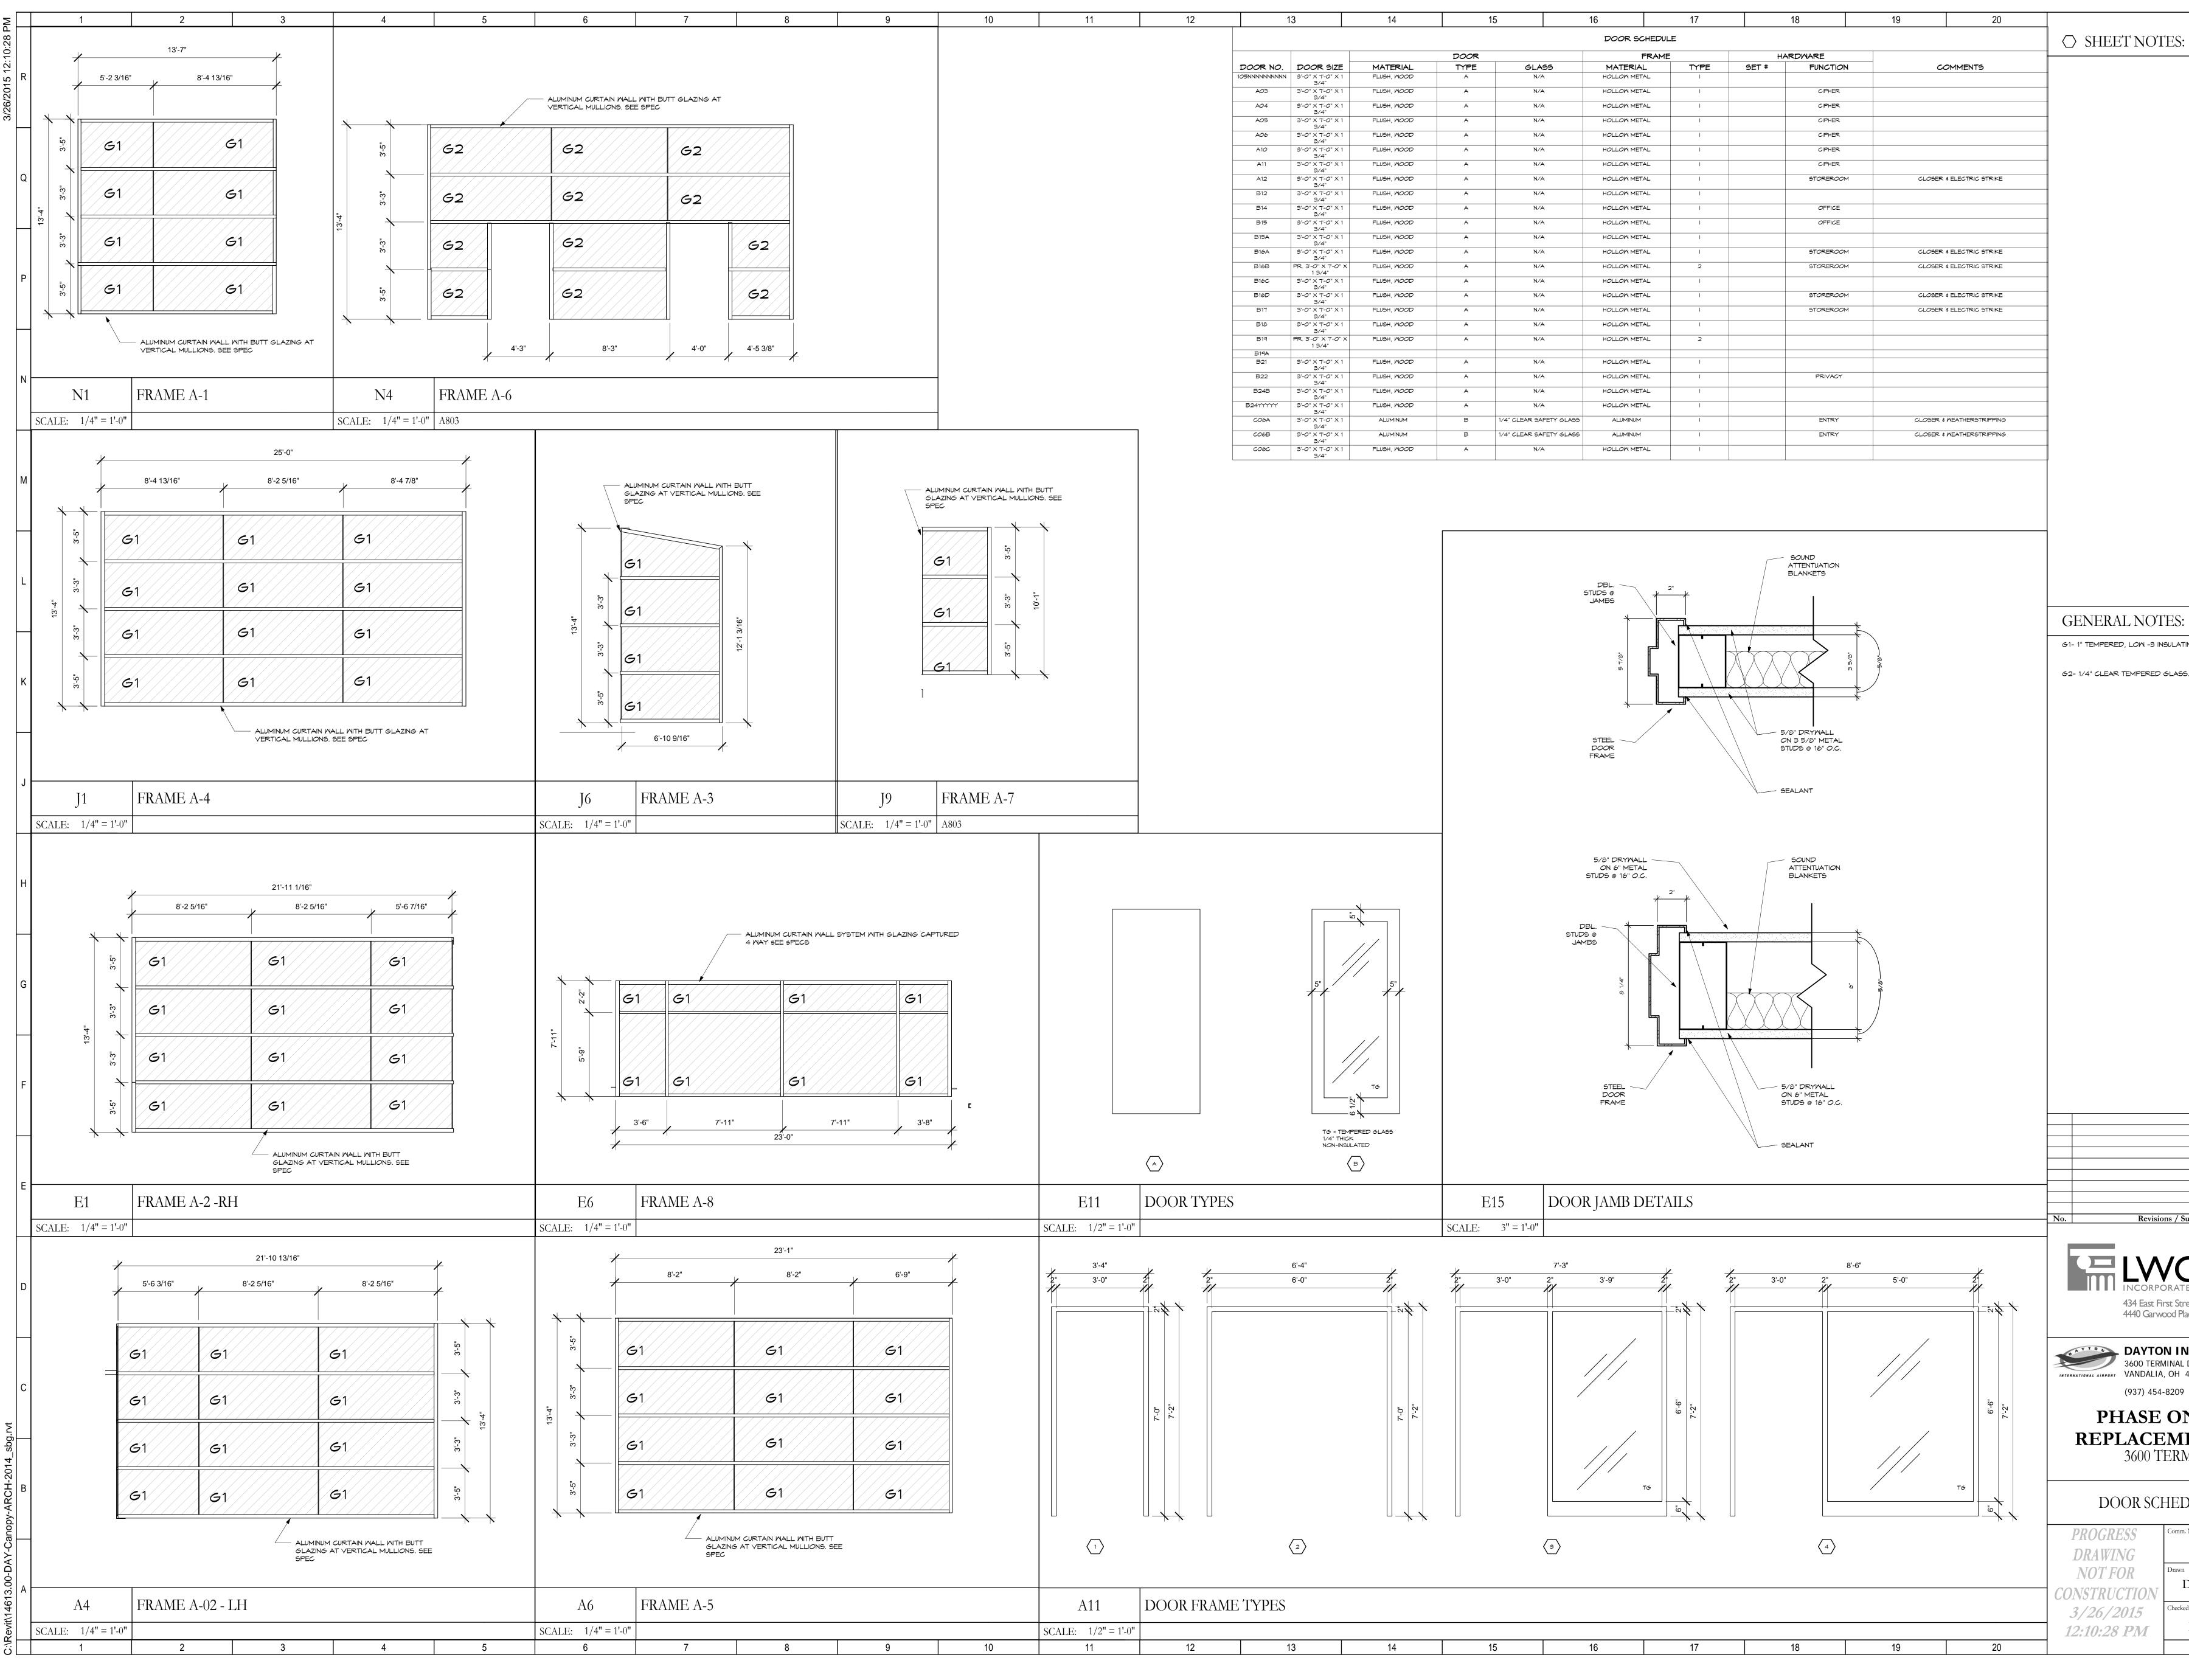
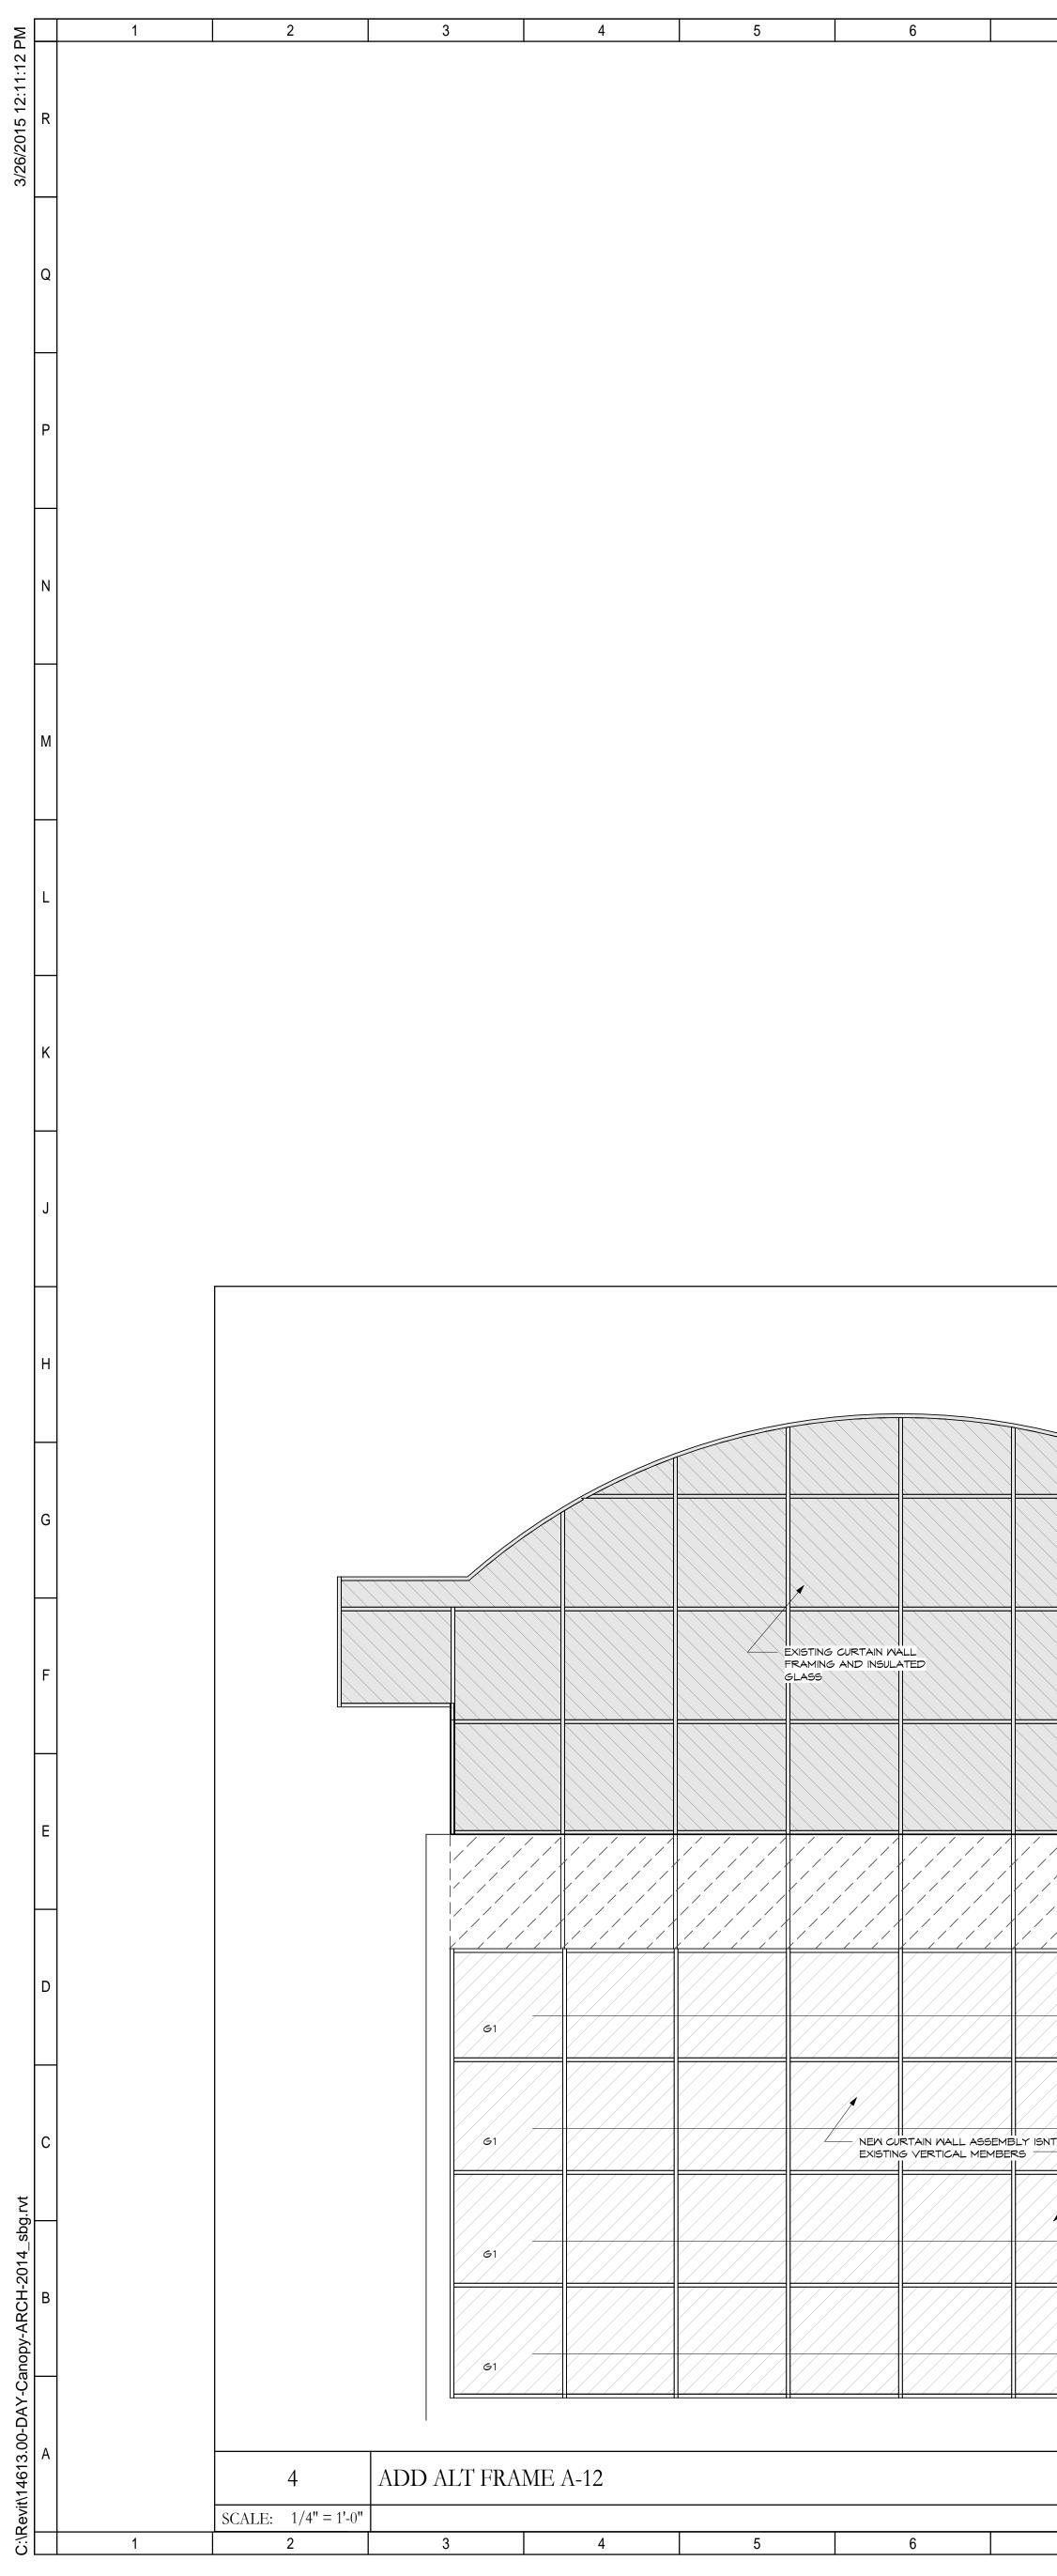


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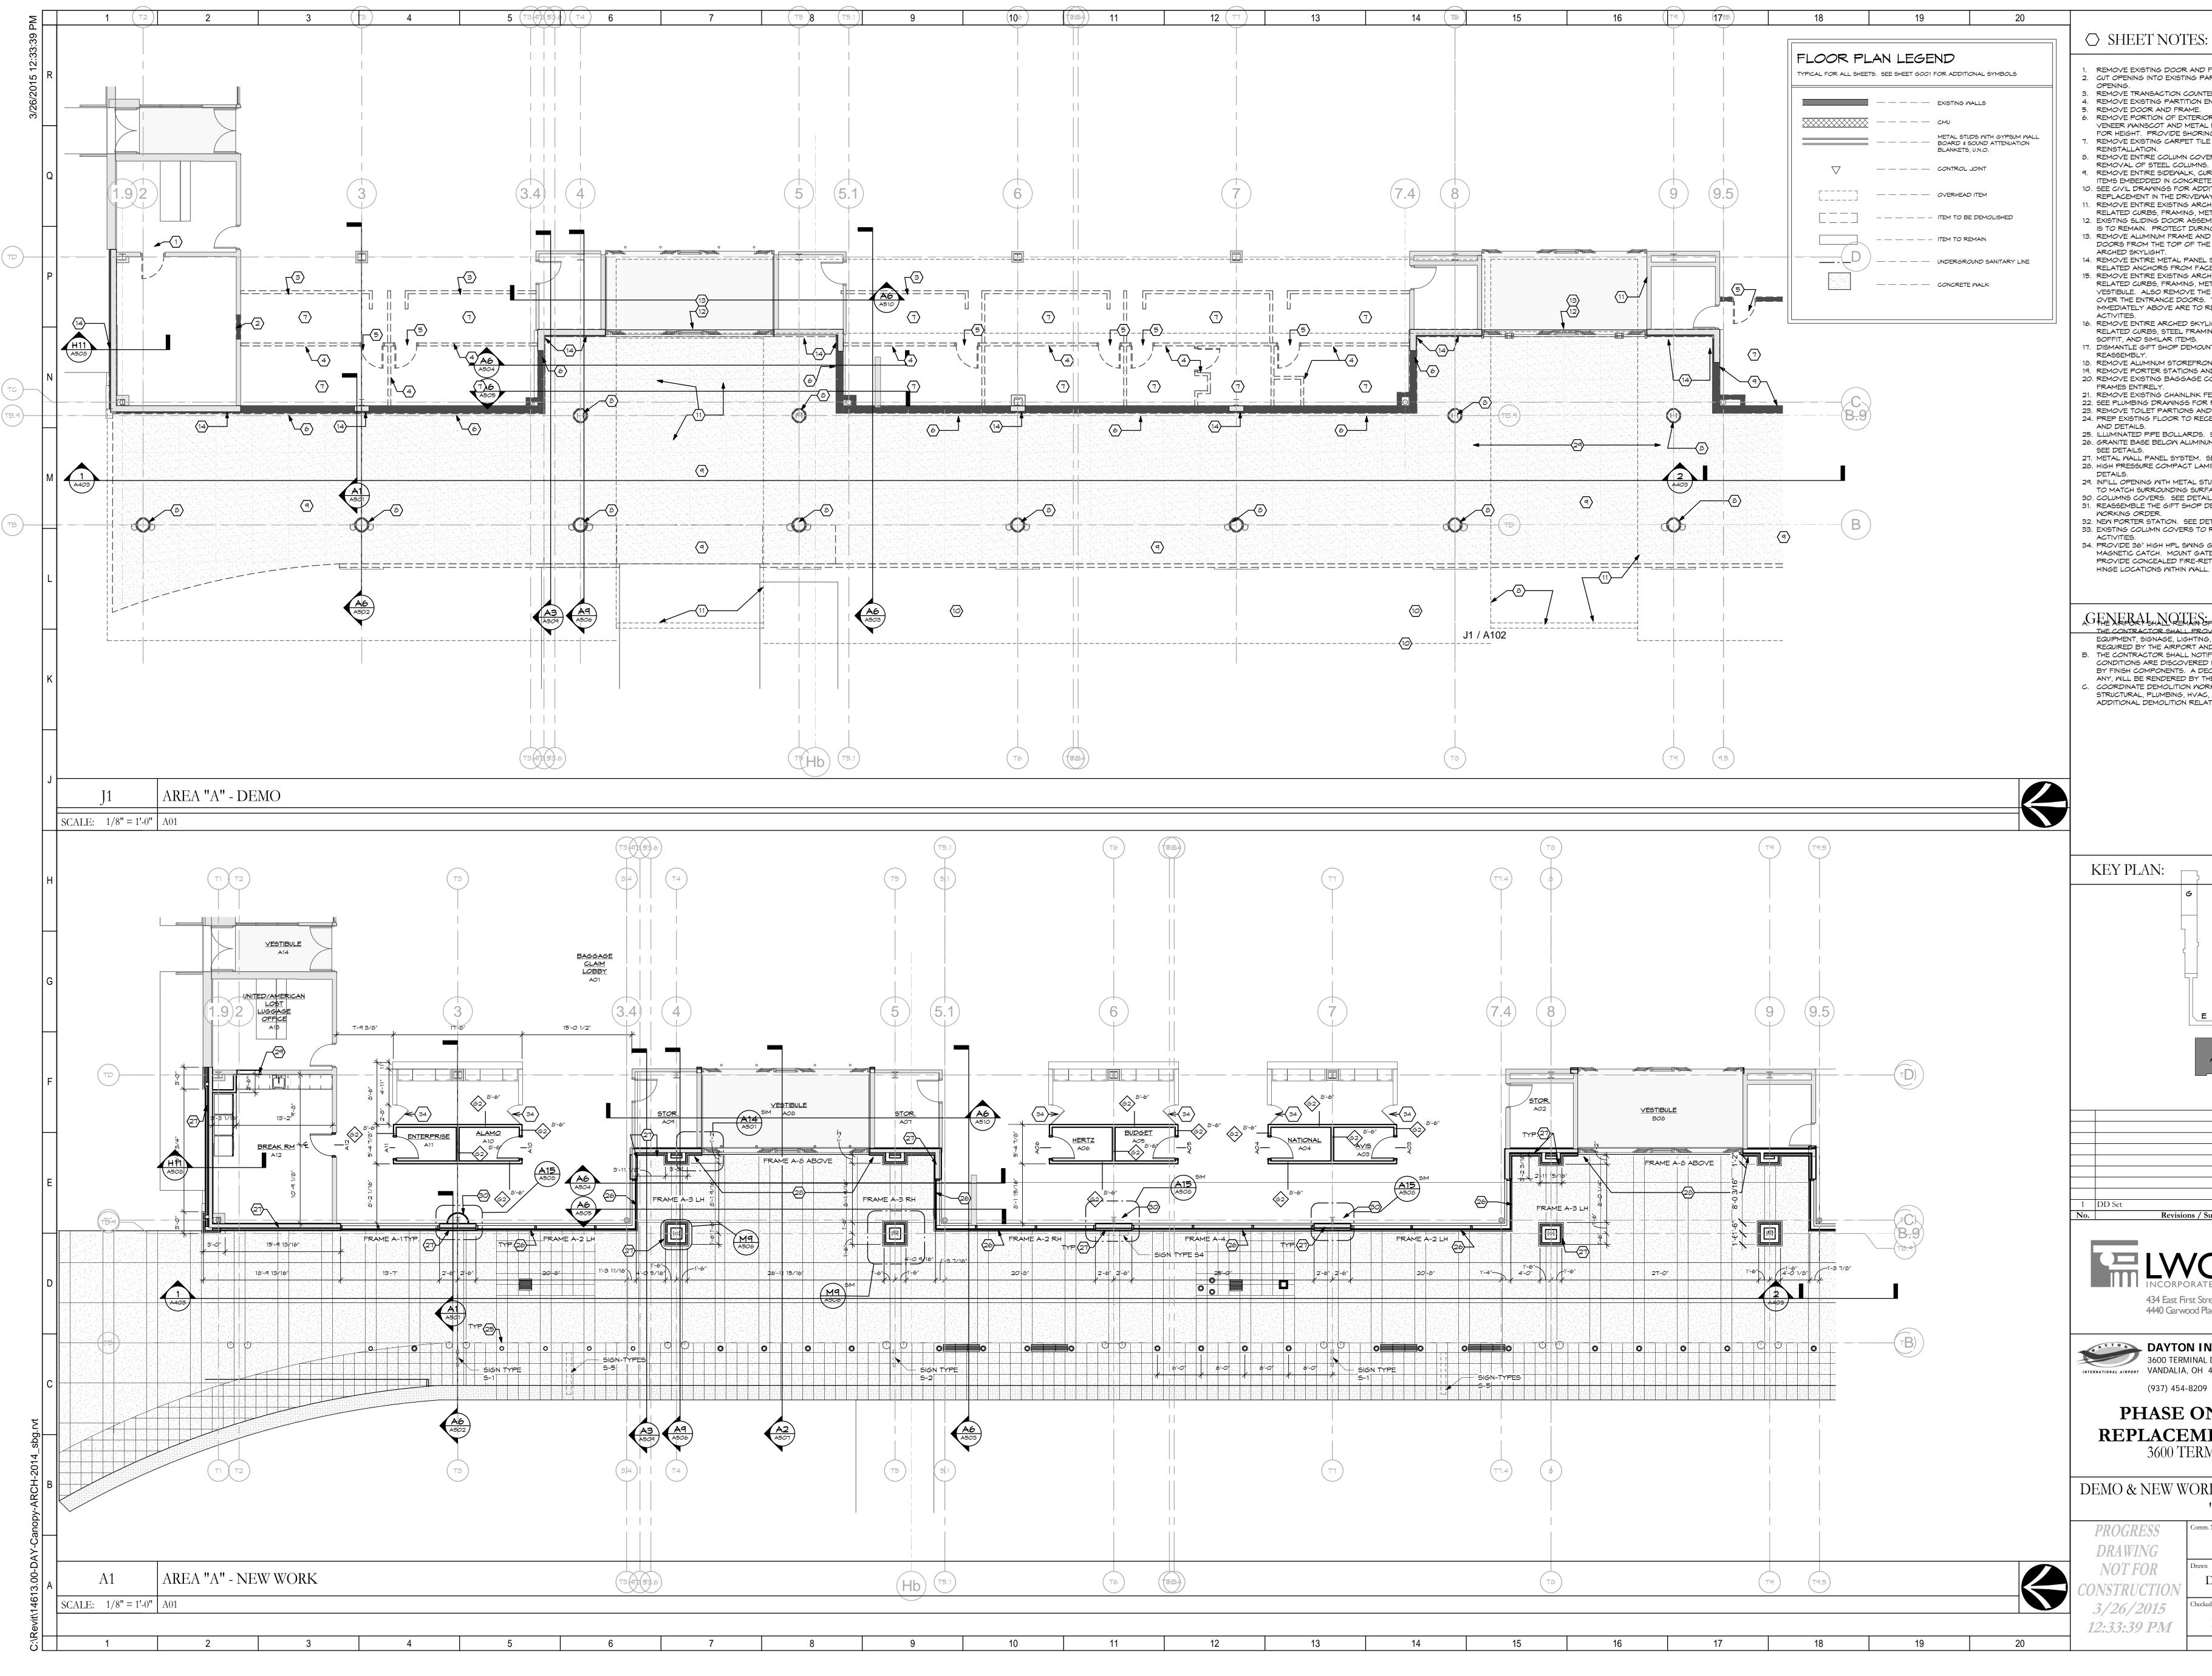
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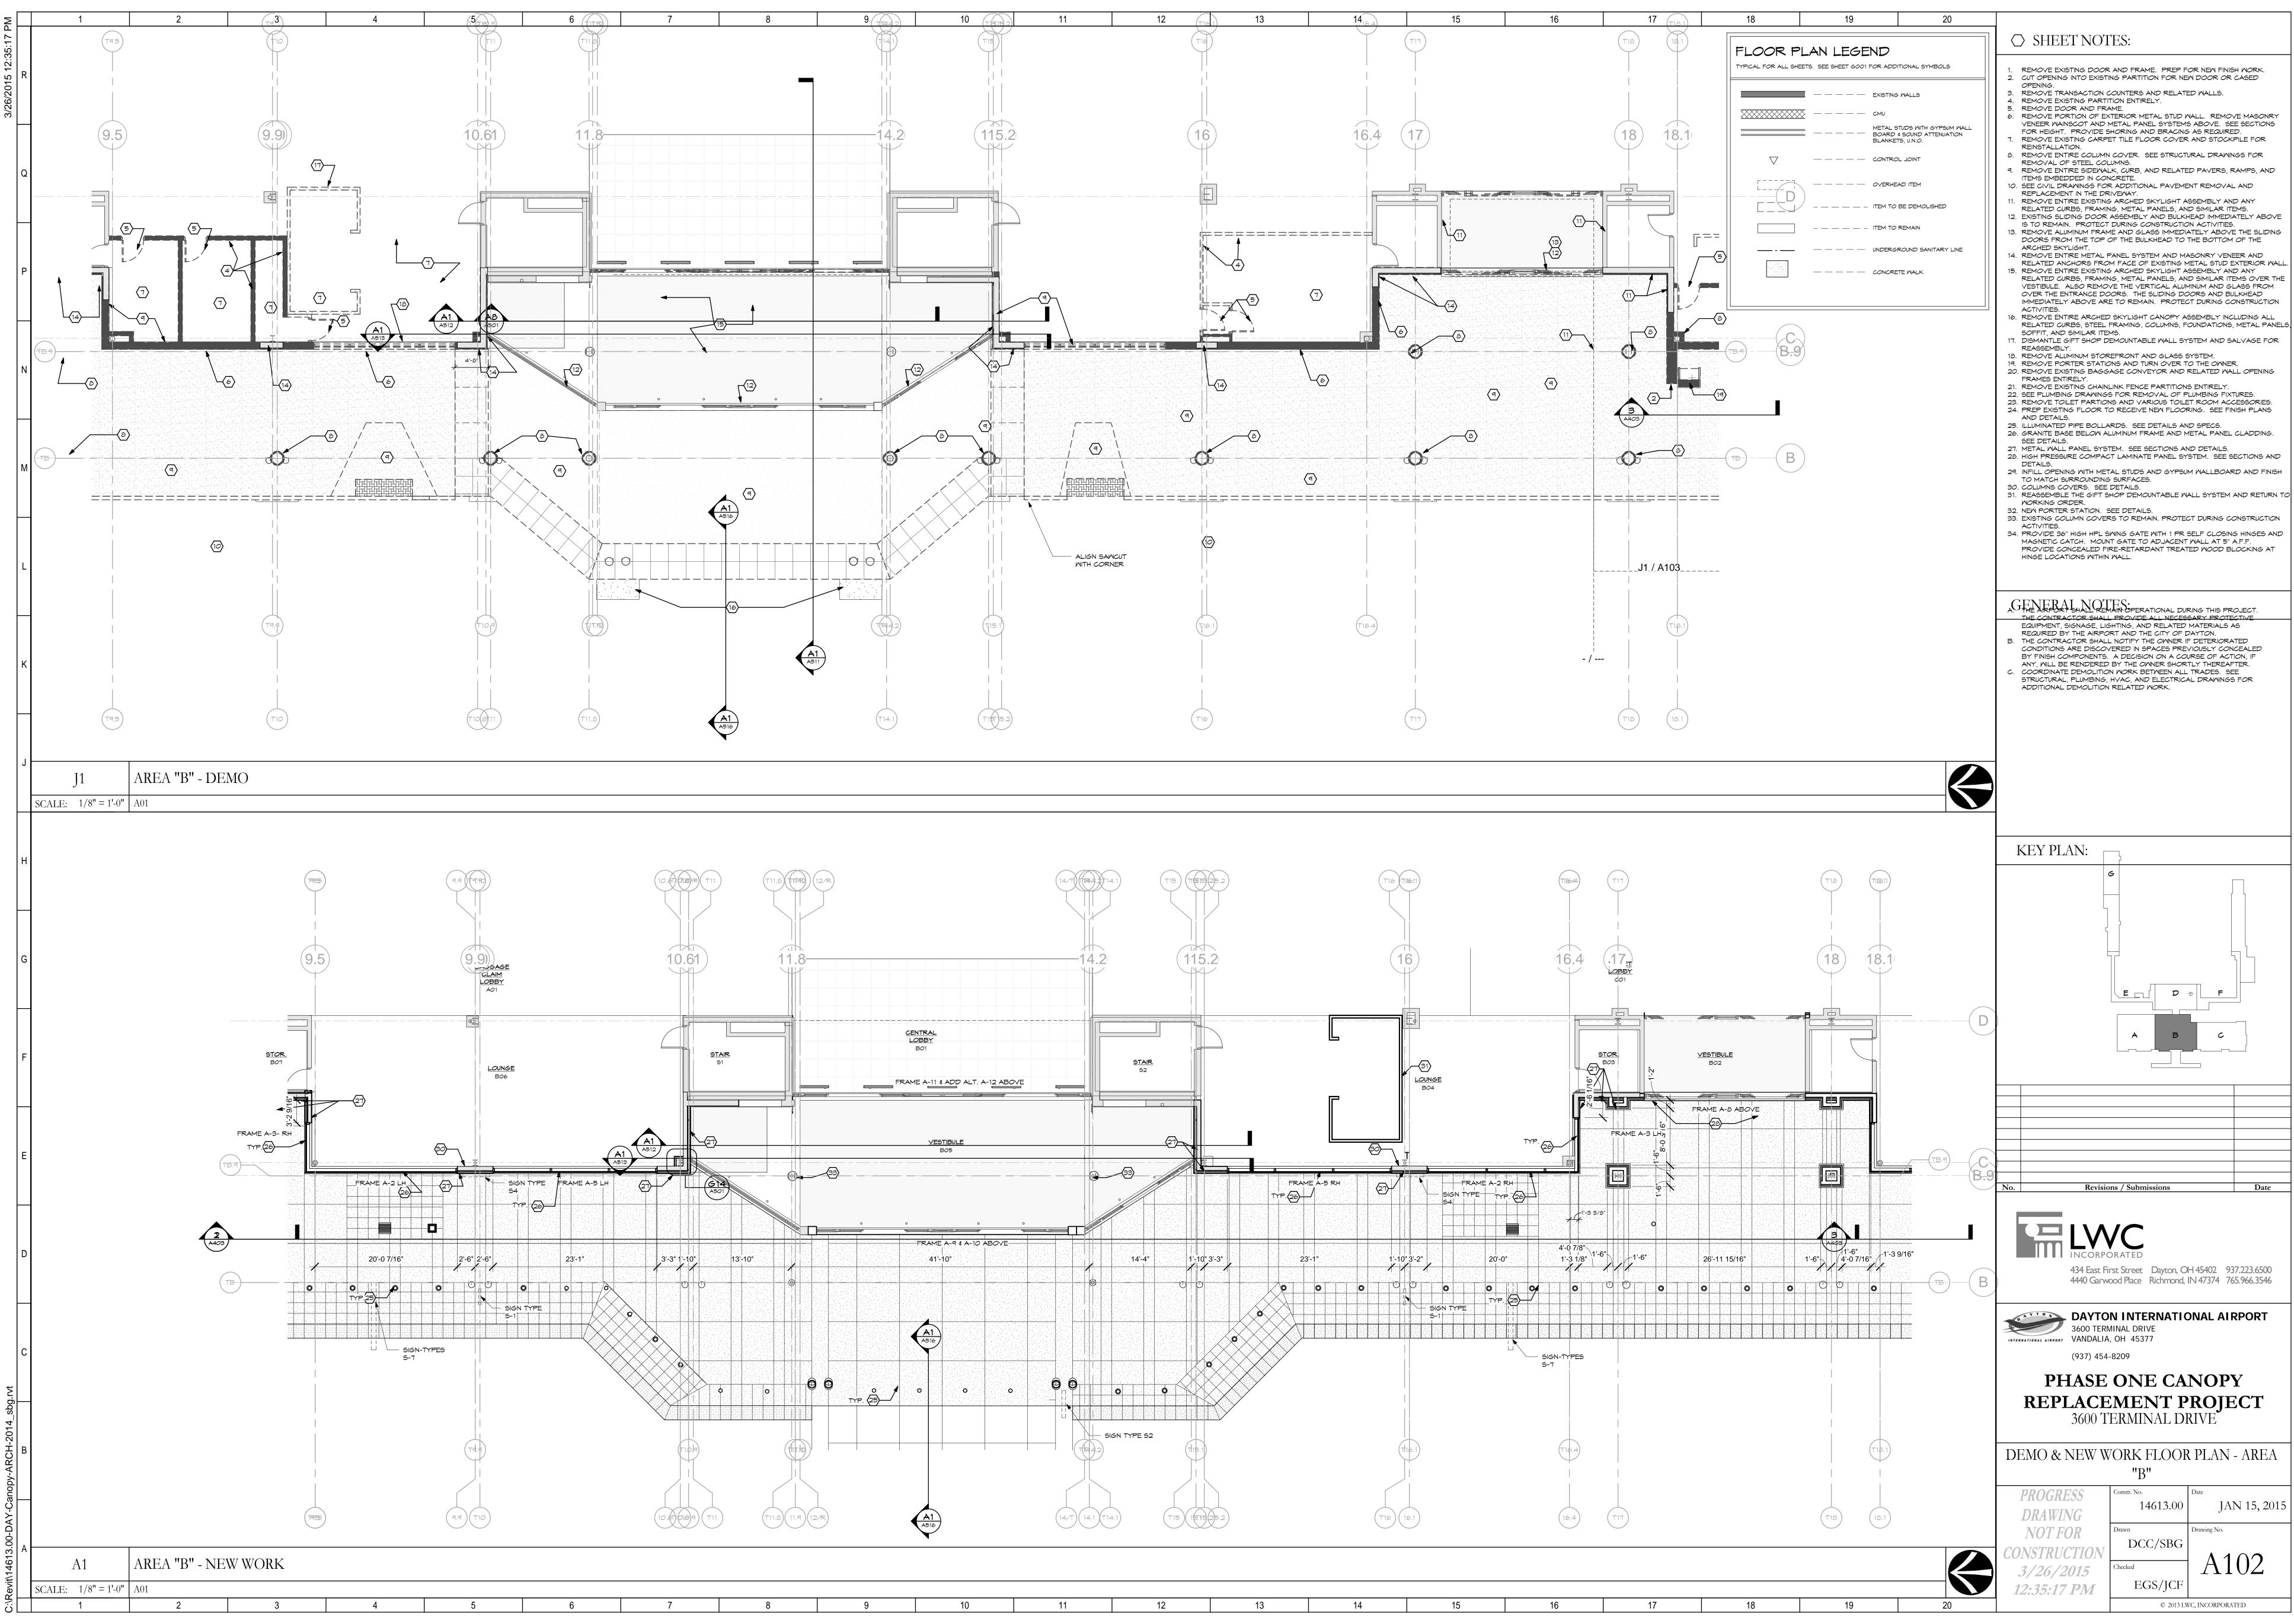
					INSULATE G CURTAINWA IN SHADED	ND REINSTALL PLASS AND ALL FRAMING AREA TO FACILITATE ON OF NEW WORK	
				2	FRAME A-11	- BASE BID	
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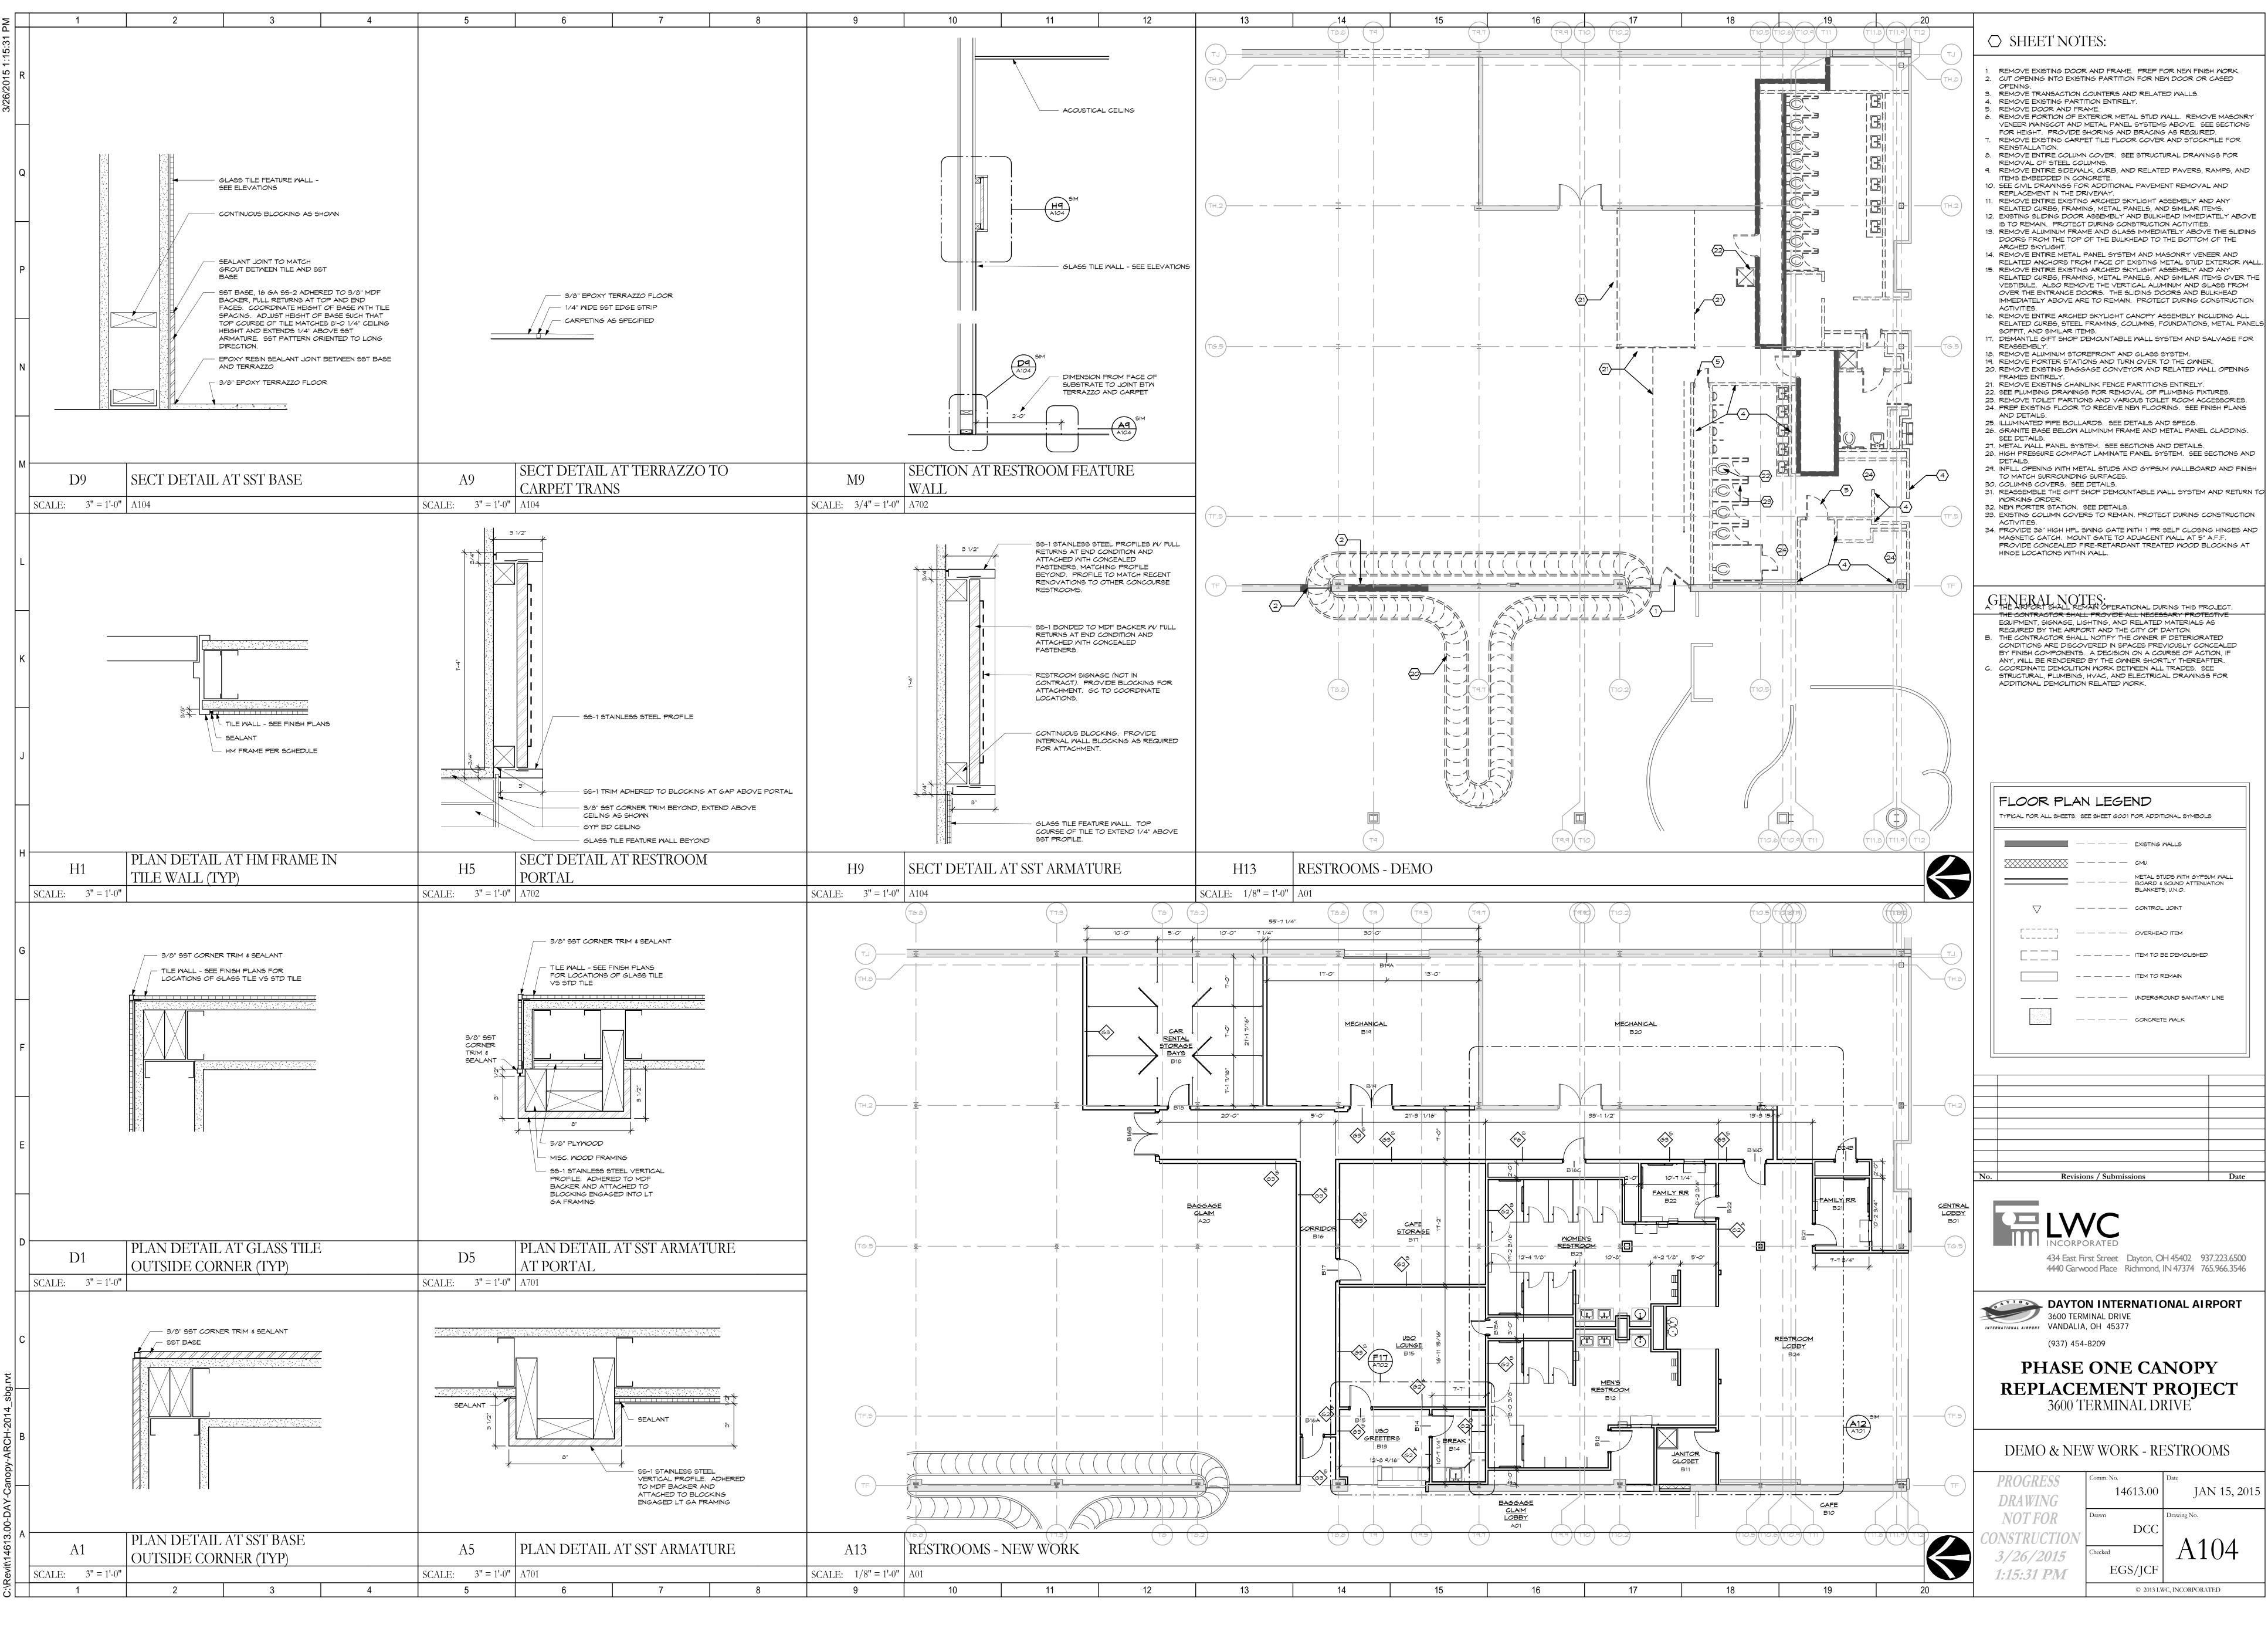
14	15 16	5 17	18	19	20	SHEET NOTES: G1- 1" TINTED, TEMPERED, LOW -3 INSULATING GLASS. SEE SPECS G2- 1/4" TINTED TEMPERED GLASS. SEE SPECS
SCALE:	G1 G1 3 FRAME 1/4" = 1'-0"	A-9	<u></u>	<u></u>	<u><u><u></u></u><u></u><u></u><u></u><u></u><u></u><u></u><u></u><u></u><u></u><u></u><u></u><u></u><u></u><u></u><u></u><u></u><u></u></u>	
	<u>61</u> <u>61</u> <u>61</u>		G1	G1		CENTER AT NICTER. 1. FEILD MEASURE AND CONFIRM OPENINGS WHERE EXISTING FRAMES ARE BEING REFPLACED WITH NEW. 2. AS REQUIRED, REMOVE AND REINSTALL PERIMETER TRIM AND FLASHING TAHT REMAINS TO FACILITATE INSTALLATION OF NEW WORK.
SCALE:	1 FRAME 1/4" = 1'-0"	A-10	EXISTING CURTAIN FRAMING AND INS	WALL TALLED GLASS		KEY PLAN:
						No. Revisions / Submissions Date
	REMOVE EXISTING INSULATING AND CURTAIN WALL FRAMING EXCEPT MAIN VERTICAL MEMBE					A34 East First Street Dayton, OH 45402 937.223.6500 4440 Garwood Place Richmond, IN 47374 765.966.3546 DAYTON INTERNATIONAL AIRPORT 3600 TERMINAL DRIVE VANDALIA, OH 45377 (937) 454-8209 PHASE ONE CANOPY REPLACEMENT PROJECT 3600 TERMINAL DRIVE
						DOOD TERMITINAL DRIVE DOOR SCHEDULE & DETAILS PROGRESS Comm. No. Date PROGRESS 14613.00 Date DRAWING Drawn Drawing No. ODATE Comm. No. Date JAN 15, 2015 Drawn Drawing No. CONSTRUCTION Checked Drawing No. Checked Checker A0003
14	15 16	5 17	18	19	20	© 2013 LWC, INCORPORATED



REMOVE EXISTING DOOR AND FRAME. PREP FOR NEW FINISH WORK. CUT OPENING INTO EXISTING PARTITION FOR NEW DOOR OR CASED REMOVE TRANSACTION COUNTERS AND RELATED WALLS. REMOVE EXISTING PARTITION ENTIRELY. REMOVE PORTION OF EXTERIOR METAL STUD WALL. REMOVE MASONRY VENEER WAINSCOT AND METAL PANEL SYSTEMS ABOVE. SEE SECTIONS FOR HEIGHT. PROVIDE SHORING AND BRACING AS REQUIRED. REMOVE EXISTING CARPET TILE FLOOR COVER AND STOCKPILE FOR REMOVE ENTIRE COLUMN COVER. SEE STRUCTURAL DRAWINGS FOR REMOVAL OF STEEL COLUMNS. REMOVE ENTIRE SIDEWALK, CURB, AND RELATED PAVERS, RAMPS, AND ITEMS EMBEDDED IN CONCRETE. 0. SEE CIVIL DRAWINGS FOR ADDITIONAL PAVEMENT REMOVAL AND REPLACEMENT IN THE DRIVEWAY. REMOVE ENTIRE EXISTING ARCHED SKYLIGHT ASSEMBLY AND ANY RELATED CURBS, FRAMING, METAL PANELS, AND SIMILAR ITEMS. 12. EXISTING SLIDING DOOR ASSEMBLY AND BULKHEAD IMMEDIATELY ABOVE IS TO REMAIN. PROTECT DURING CONSTRUCTION ACTIVITIES. 13. REMOVE ALUMINUM FRAME AND GLASS IMMEDIATELY ABOVE THE SLIDING DOORS FROM THE TOP OF THE BULKHEAD TO THE BOTTOM OF THE 4. REMOVE ENTIRE METAL PANEL SYSTEM AND MASONRY VENEER AND RELATED ANCHORS FROM FACE OF EXISTING METAL STUD EXTERIOR WALL. 5. REMOVE ENTIRE EXISTING ARCHED SKYLIGHT ASSEMBLY AND ANY RELATED CURBS, FRAMING, METAL PANELS, AND SIMILAR ITEMS OVER THE VESTIBULE. ALSO REMOVE THE VERTICAL ALUMINUM AND GLASS FROM OVER THE ENTRANCE DOORS. THE SLIDING DOORS AND BULKHEAD IMMEDIATELY ABOVE ARE TO REMAIN. PROTECT DURING CONSTRUCTION 16. REMOVE ENTIRE ARCHED SKYLIGHT CANOPY ASSEMBLY INCLUDING ALL RELATED CURBS, STEEL FRAMING, COLUMNS, FOUNDATIONS, METAL PANELS 17. DISMANTLE GIFT SHOP DEMOUNTABLE WALL SYSTEM AND SALVAGE FOR 18. REMOVE ALUMINUM STOREFRONT AND GLASS SYSTEM. 19. REMOVE PORTER STATIONS AND TURN OVER TO THE OWNER. 20. REMOVE EXISTING BAGGAGE CONVEYOR AND RELATED WALL OPENING 1. REMOVE EXISTING CHAINLINK FENCE PARTITIONS ENTIRELY. 22. SEE PLUMBING DRAWINGS FOR REMOVAL OF PLUMBING FIXTURES. 23. REMOVE TOILET PARTIONS AND VARIOUS TOILET ROOM ACCESSORIES. 24. PREP EXISTING FLOOR TO RECEIVE NEW FLOORING. SEE FINISH PLANS 25. ILLUMINATED PIPE BOLLARDS. SEE DETAILS AND SPECS. 26. GRANITE BASE BELOW ALUMINUM FRAME AND METAL PANEL CLADDING. 27. METAL WALL PANEL SYSTEM. SEE SECTIONS AND DETAILS. 28. HIGH PRESSURE COMPACT LAMINATE PANEL SYSTEM. SEE SECTIONS AND 29. INFILL OPENING WITH METAL STUDS AND GYPSUM WALLBOARD AND FINISH TO MATCH SURROUNDING SURFACES. 30. COLUMNS COVERS. SEE DETAILS. 31. REASSEMBLE THE GIFT SHOP DEMOUNTABLE WALL SYSTEM AND RETURN TO 32. NEW PORTER STATION. SEE DETAILS. 33. EXISTING COLUMN COVERS TO REMAIN. PROTECT DURING CONSTRUCTION 34. PROVIDE 36" HIGH HPL SWING GATE WITH 1 PR SELF CLOSING HINGES AND MAGNETIC CATCH. MOUNT GATE TO ADJACENT WALL AT 5" A.F.F. PROVIDE CONCEALED FIRE-RETARDANT TREATED WOOD BLOCKING AT HINGE LOCATIONS WITHIN WALL. AGENERAL NOTES: THE CONTRACTOR SHALL PROVIDE ALL NECESSARY PROTECTIVE EQUIPMENT, SIGNAGE, LIGHTING, AND RELATED MATERIALS AS REQUIRED BY THE AIRPORT AND THE CITY OF DAYTON. . THE CONTRACTOR SHALL NOTIFY THE OWNER IF DETERIORATED CONDITIONS ARE DISCOVERED IN SPACES PREVIOUSLY CONCEALED BY FINISH COMPONENTS. A DECISION ON A COURSE OF ACTION, IF ANY, WILL BE RENDERED BY THE OWNER SHORTLY THEREAFTER. COORDINATE DEMOLITION WORK BETWEEN ALL TRADES. SEE STRUCTURAL, PLUMBING, HVAC, AND ELECTRICAL DRAWINGS FOR ADDITIONAL DEMOLITION RELATED WORK. D 11-3-2014 **Revisions / Submissions** Date NCORPORATED 434 East First Street Dayton, OH 45402 937.223.6500 4440 Garwood Place Richmond, IN 47374 765.966.3546 DAYTON INTERNATIONAL AIRPORT 3600 TERMINAL DRIVE INTERNATIONAL AIRPORT VANDALIA, OH 45377 (937) 454-8209 PHASE ONE CANOPY **REPLACEMENT PROJECT** 3600 TERMINAL DRIVE DEMO & NEW WORK FLOOR PLAN - AREA "A" lomm. No. JAN 15, 2015 14613.00 Drawing No. DCC/SBG A101 Checked EGS/JCF



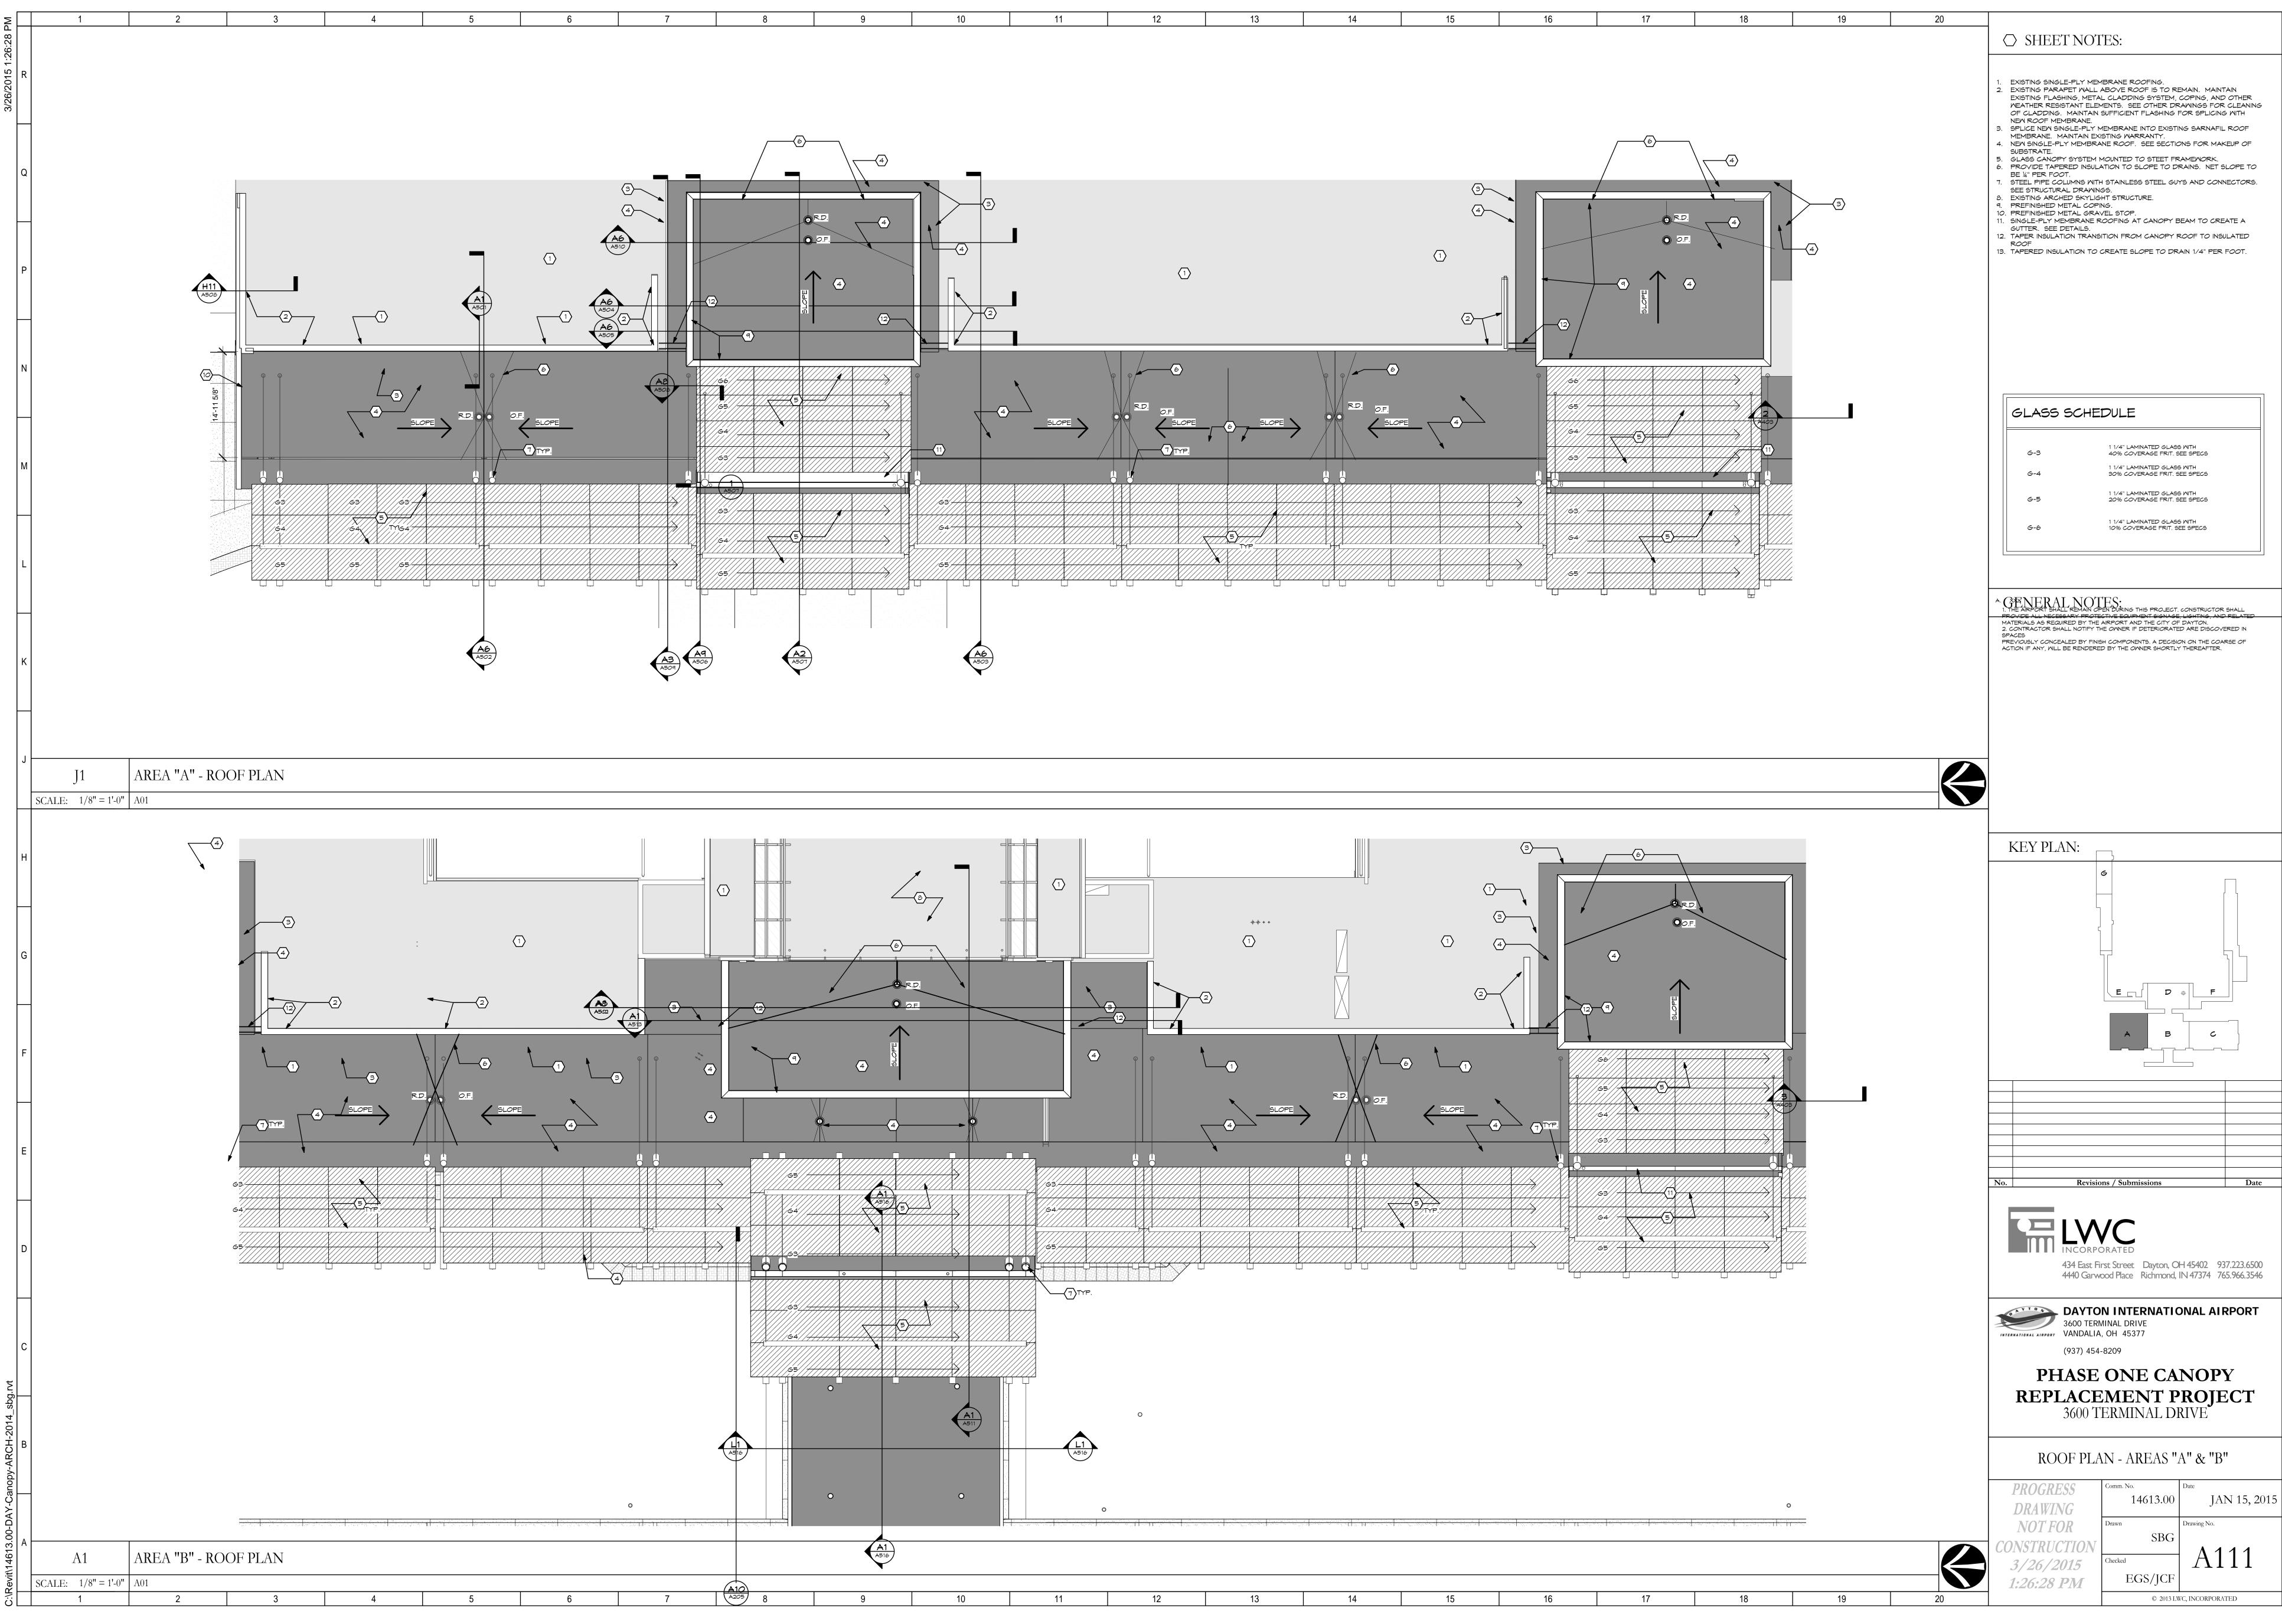


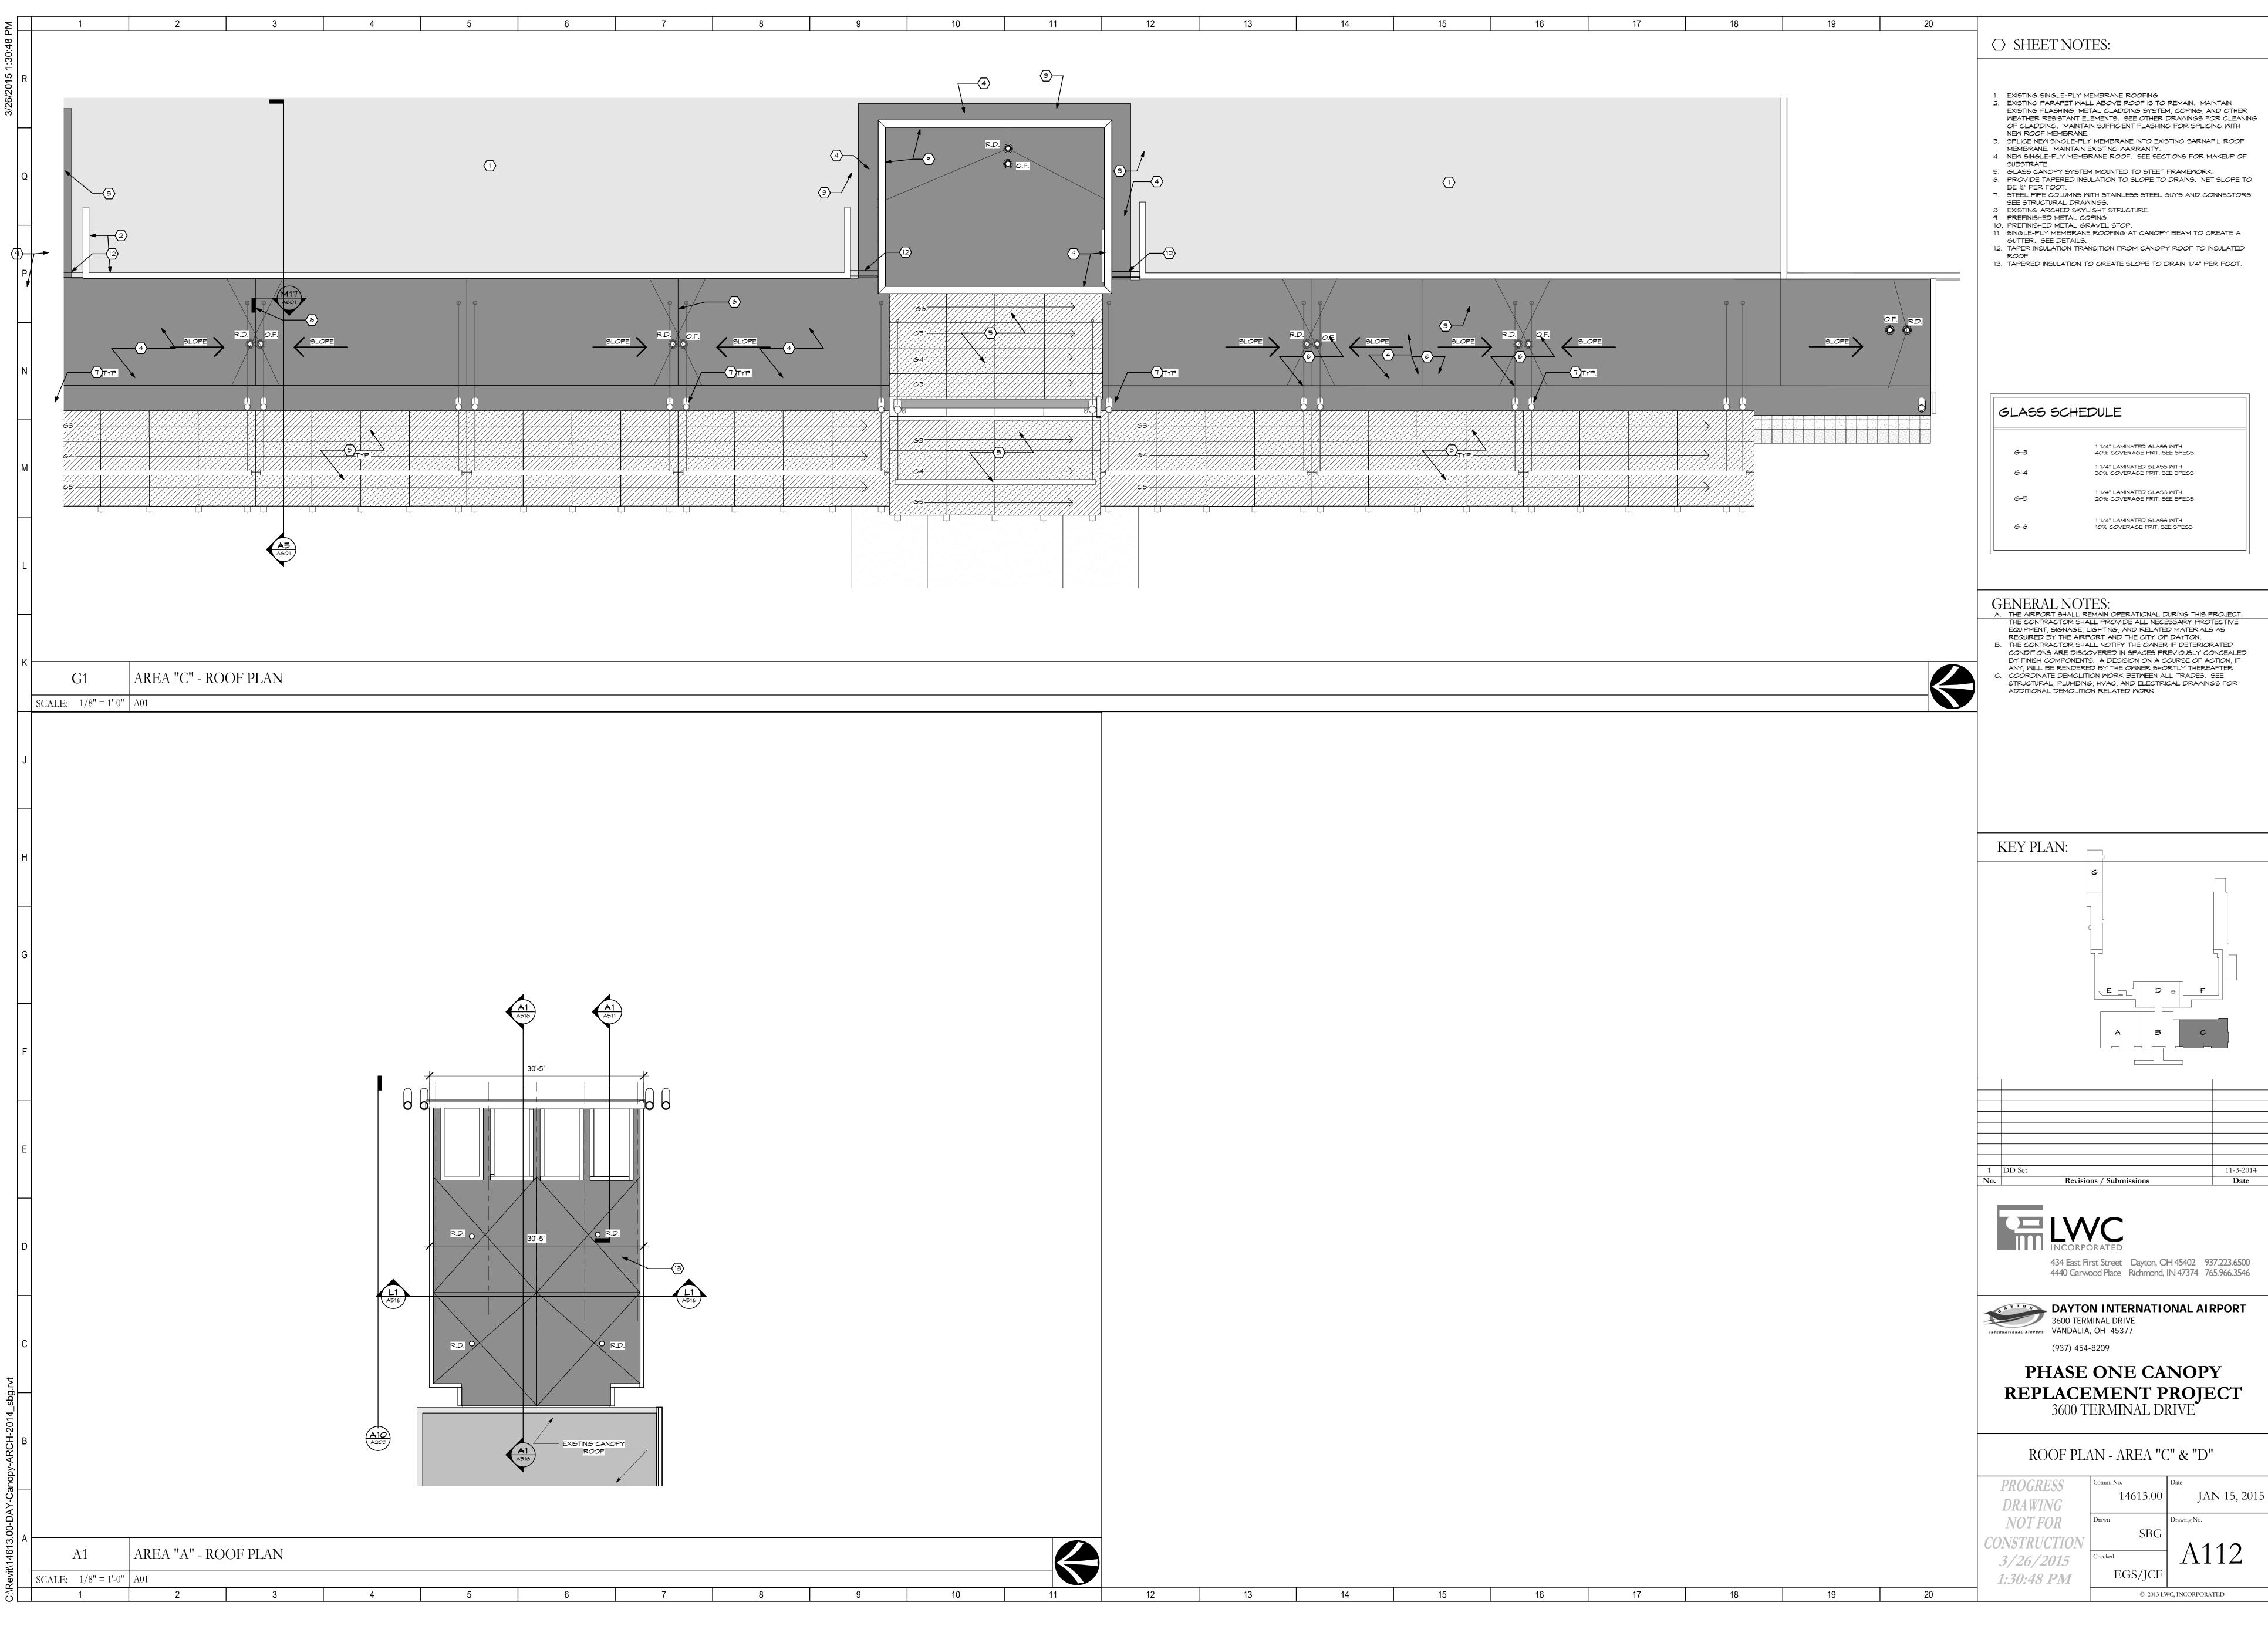


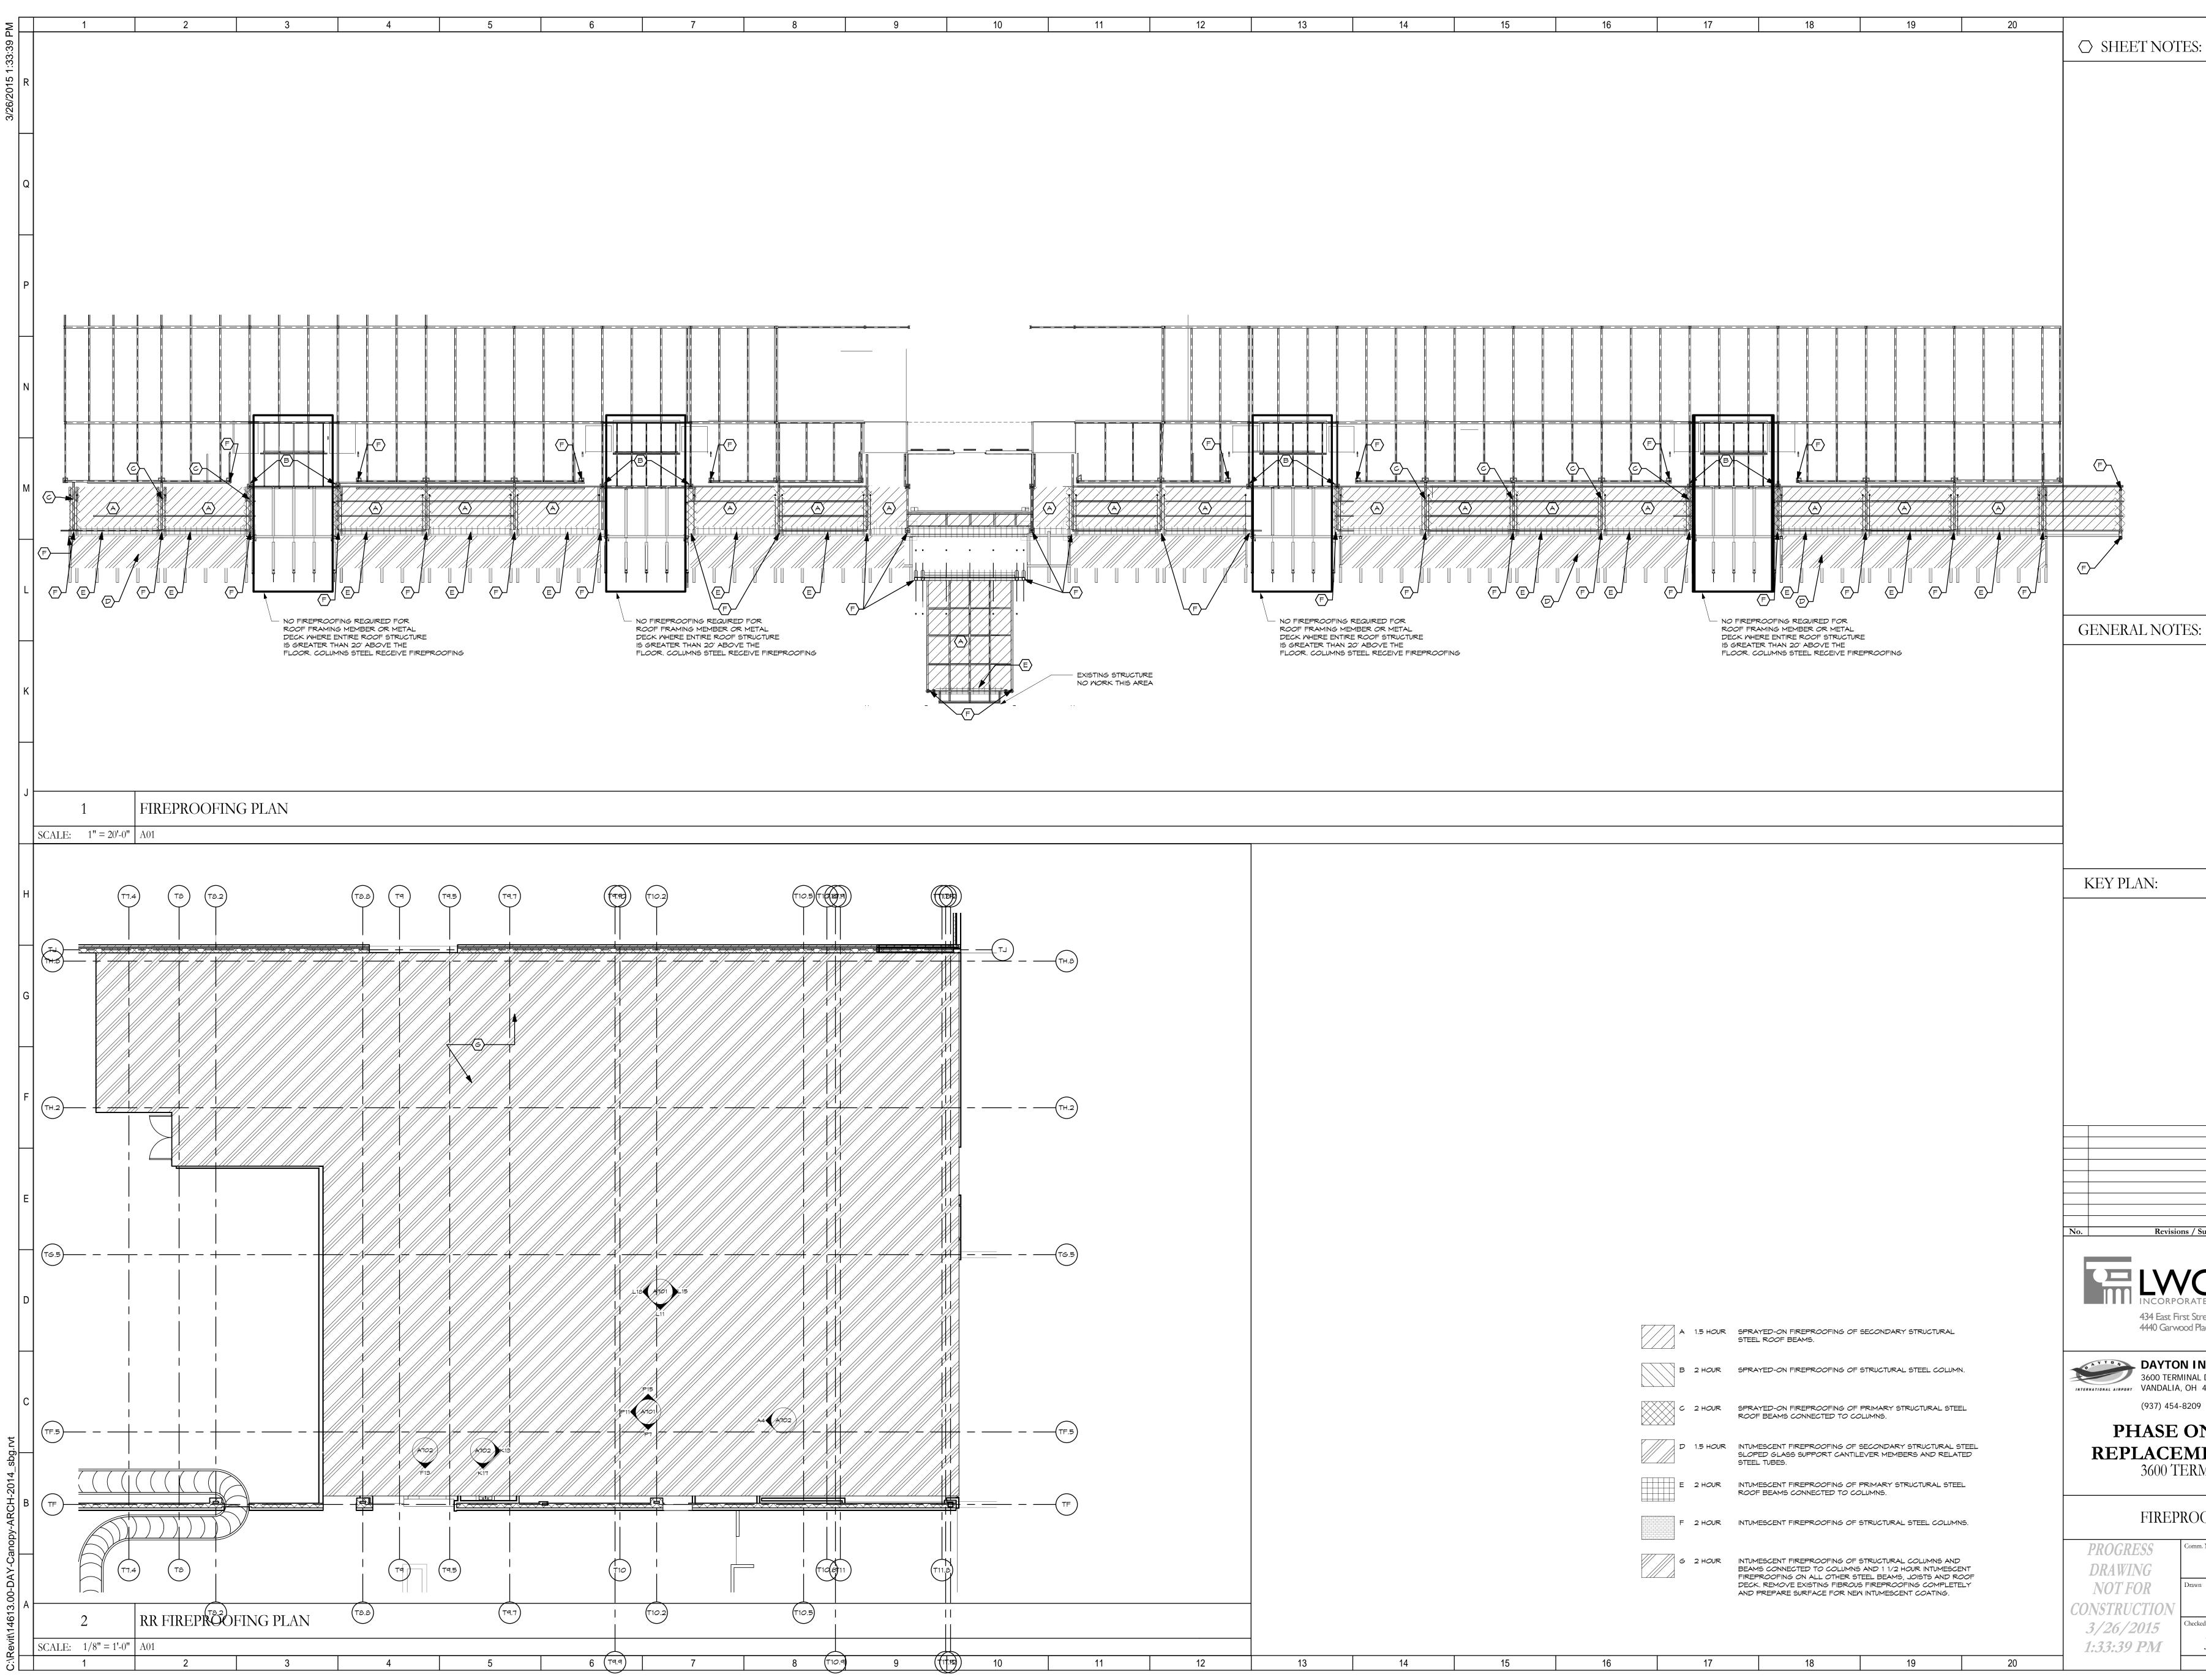
PLAN LEGEND . SHEETS. SEE SHEET GOOT FOR ADDITIONAL SYMBOLS					
		EXISTING WALLS			
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		METAL STUDS WITH GYPSUM WALL BOARD & SOUND ATTENUATION BLANKETS, U.N.O.			
		CONTROL JOINT			
 		OVERHEAD ITEM			
		ITEM TO BE DEMOLISHED			
		ITEM TO REMAIN			
		UNDERGROUND SANITARY LINE			
		CONCRETE WALK			

Revisions / Submissions	Date

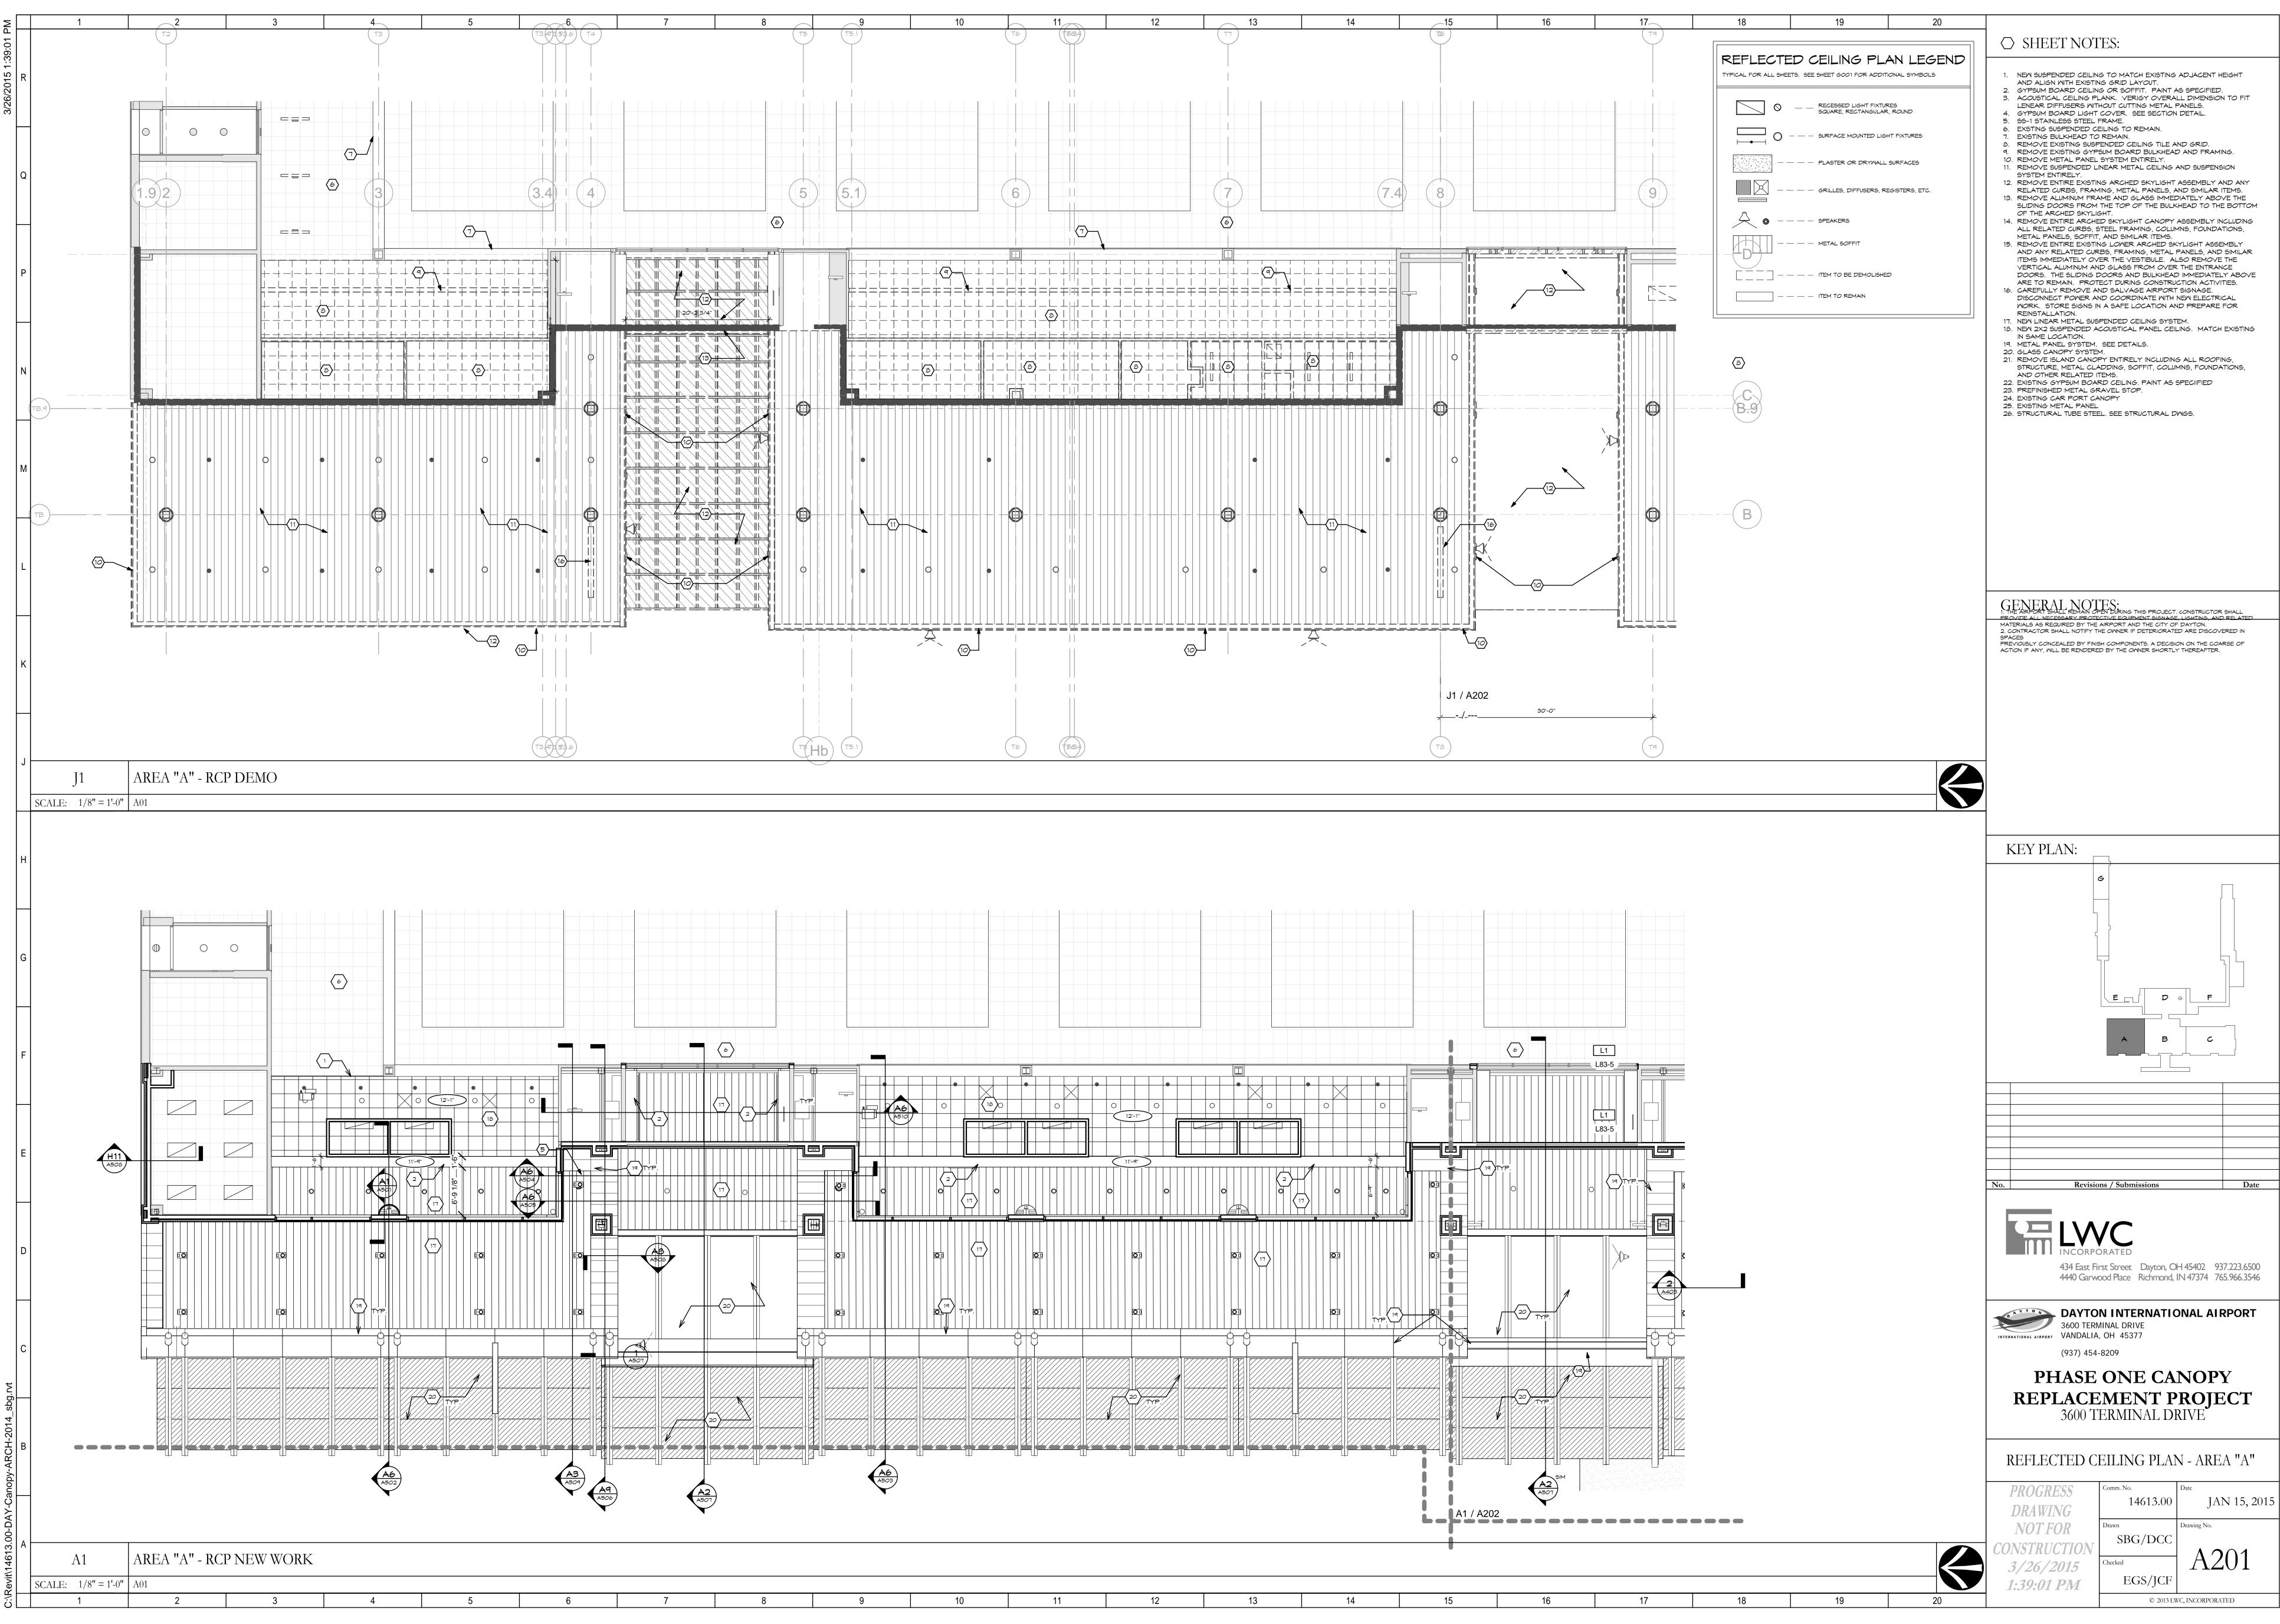




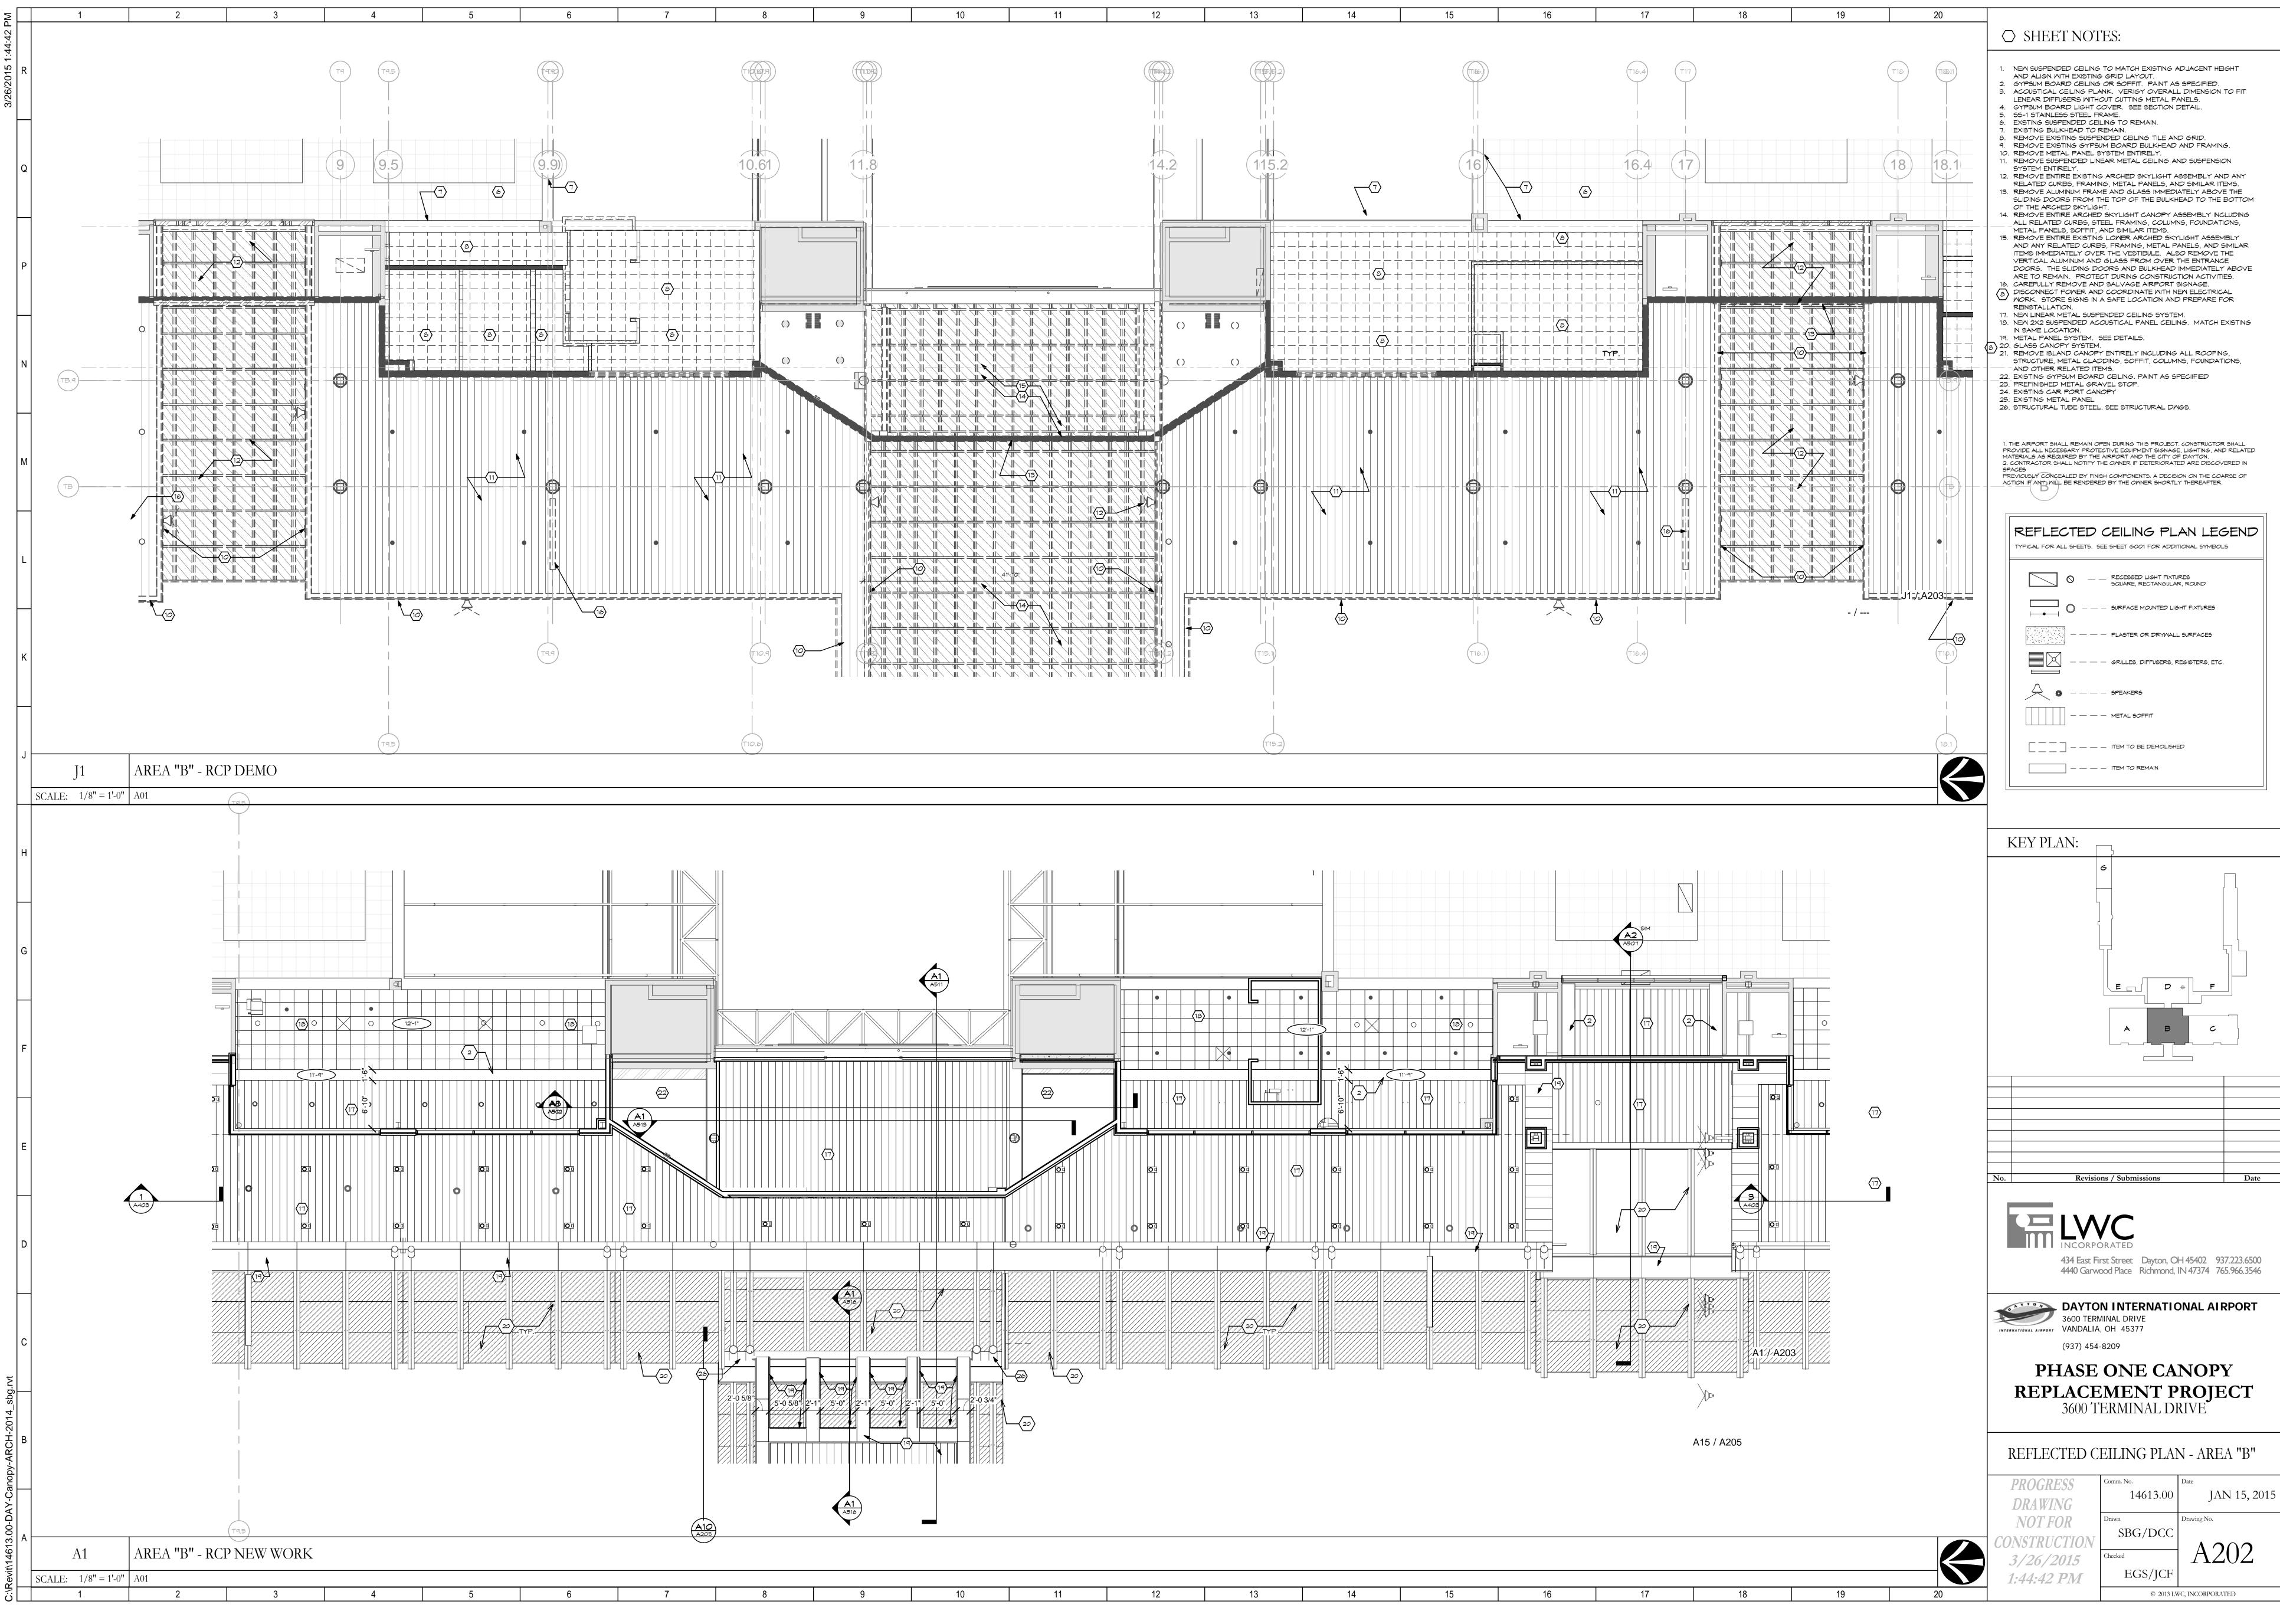




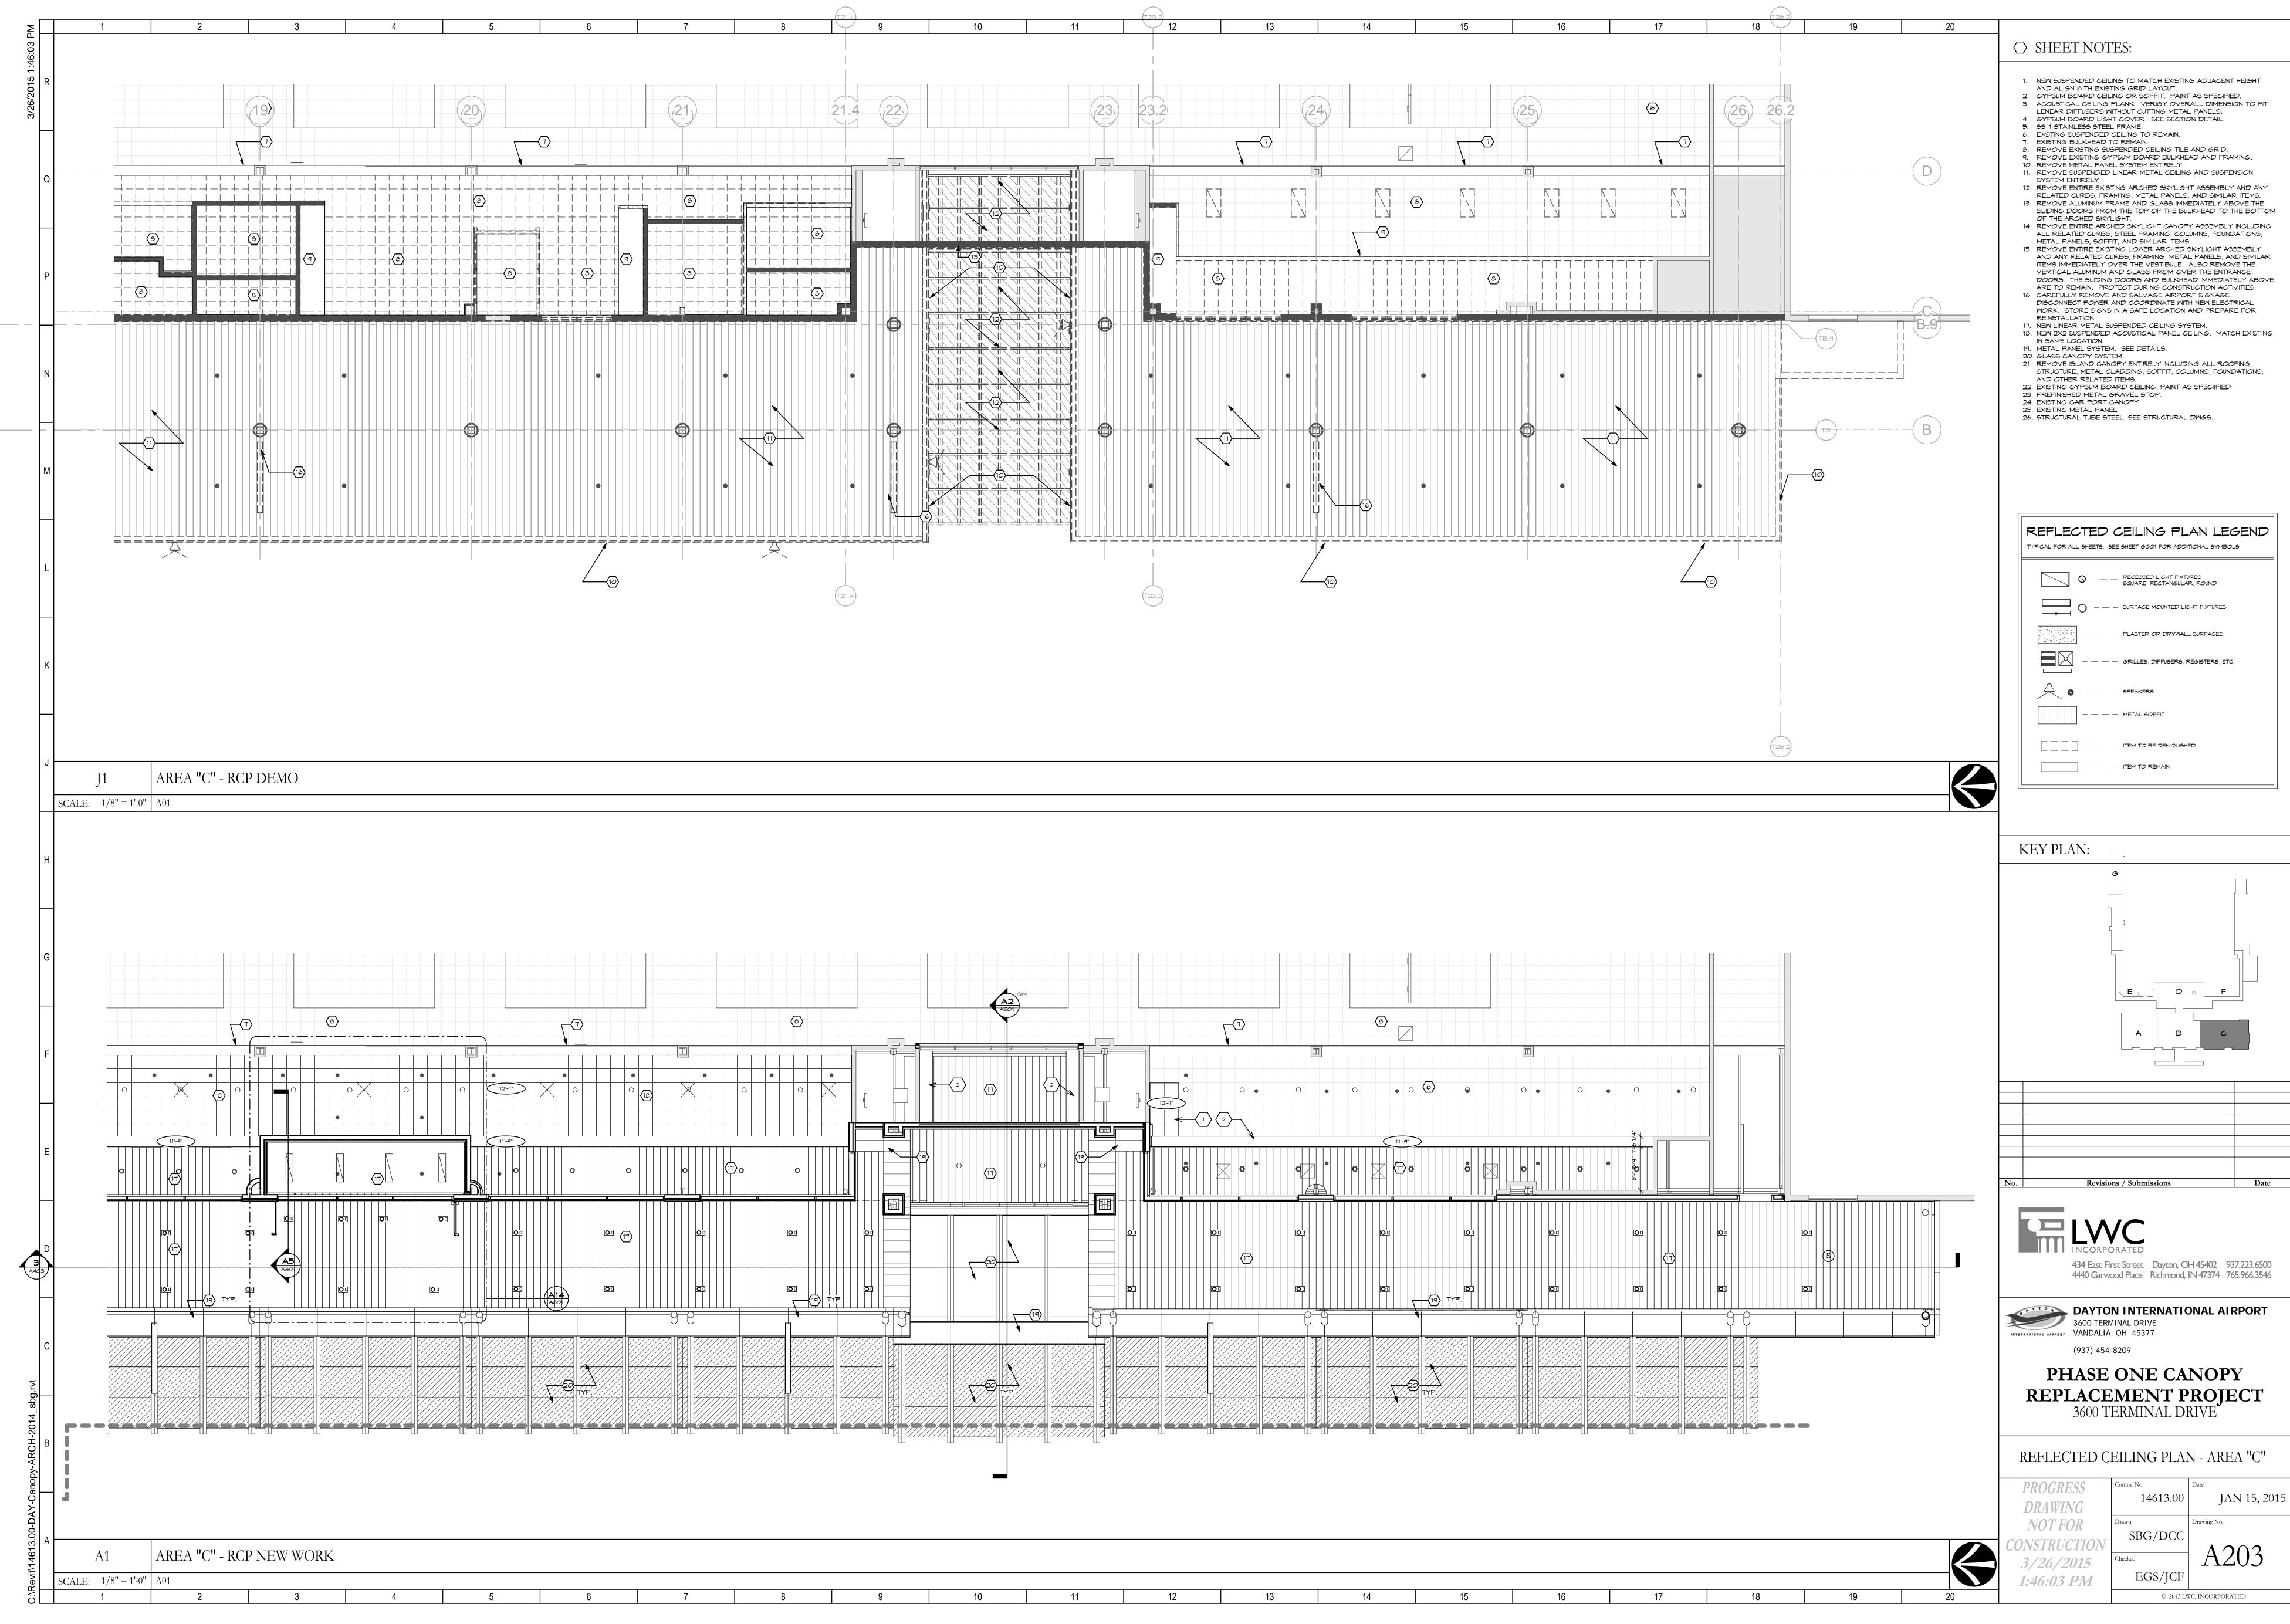
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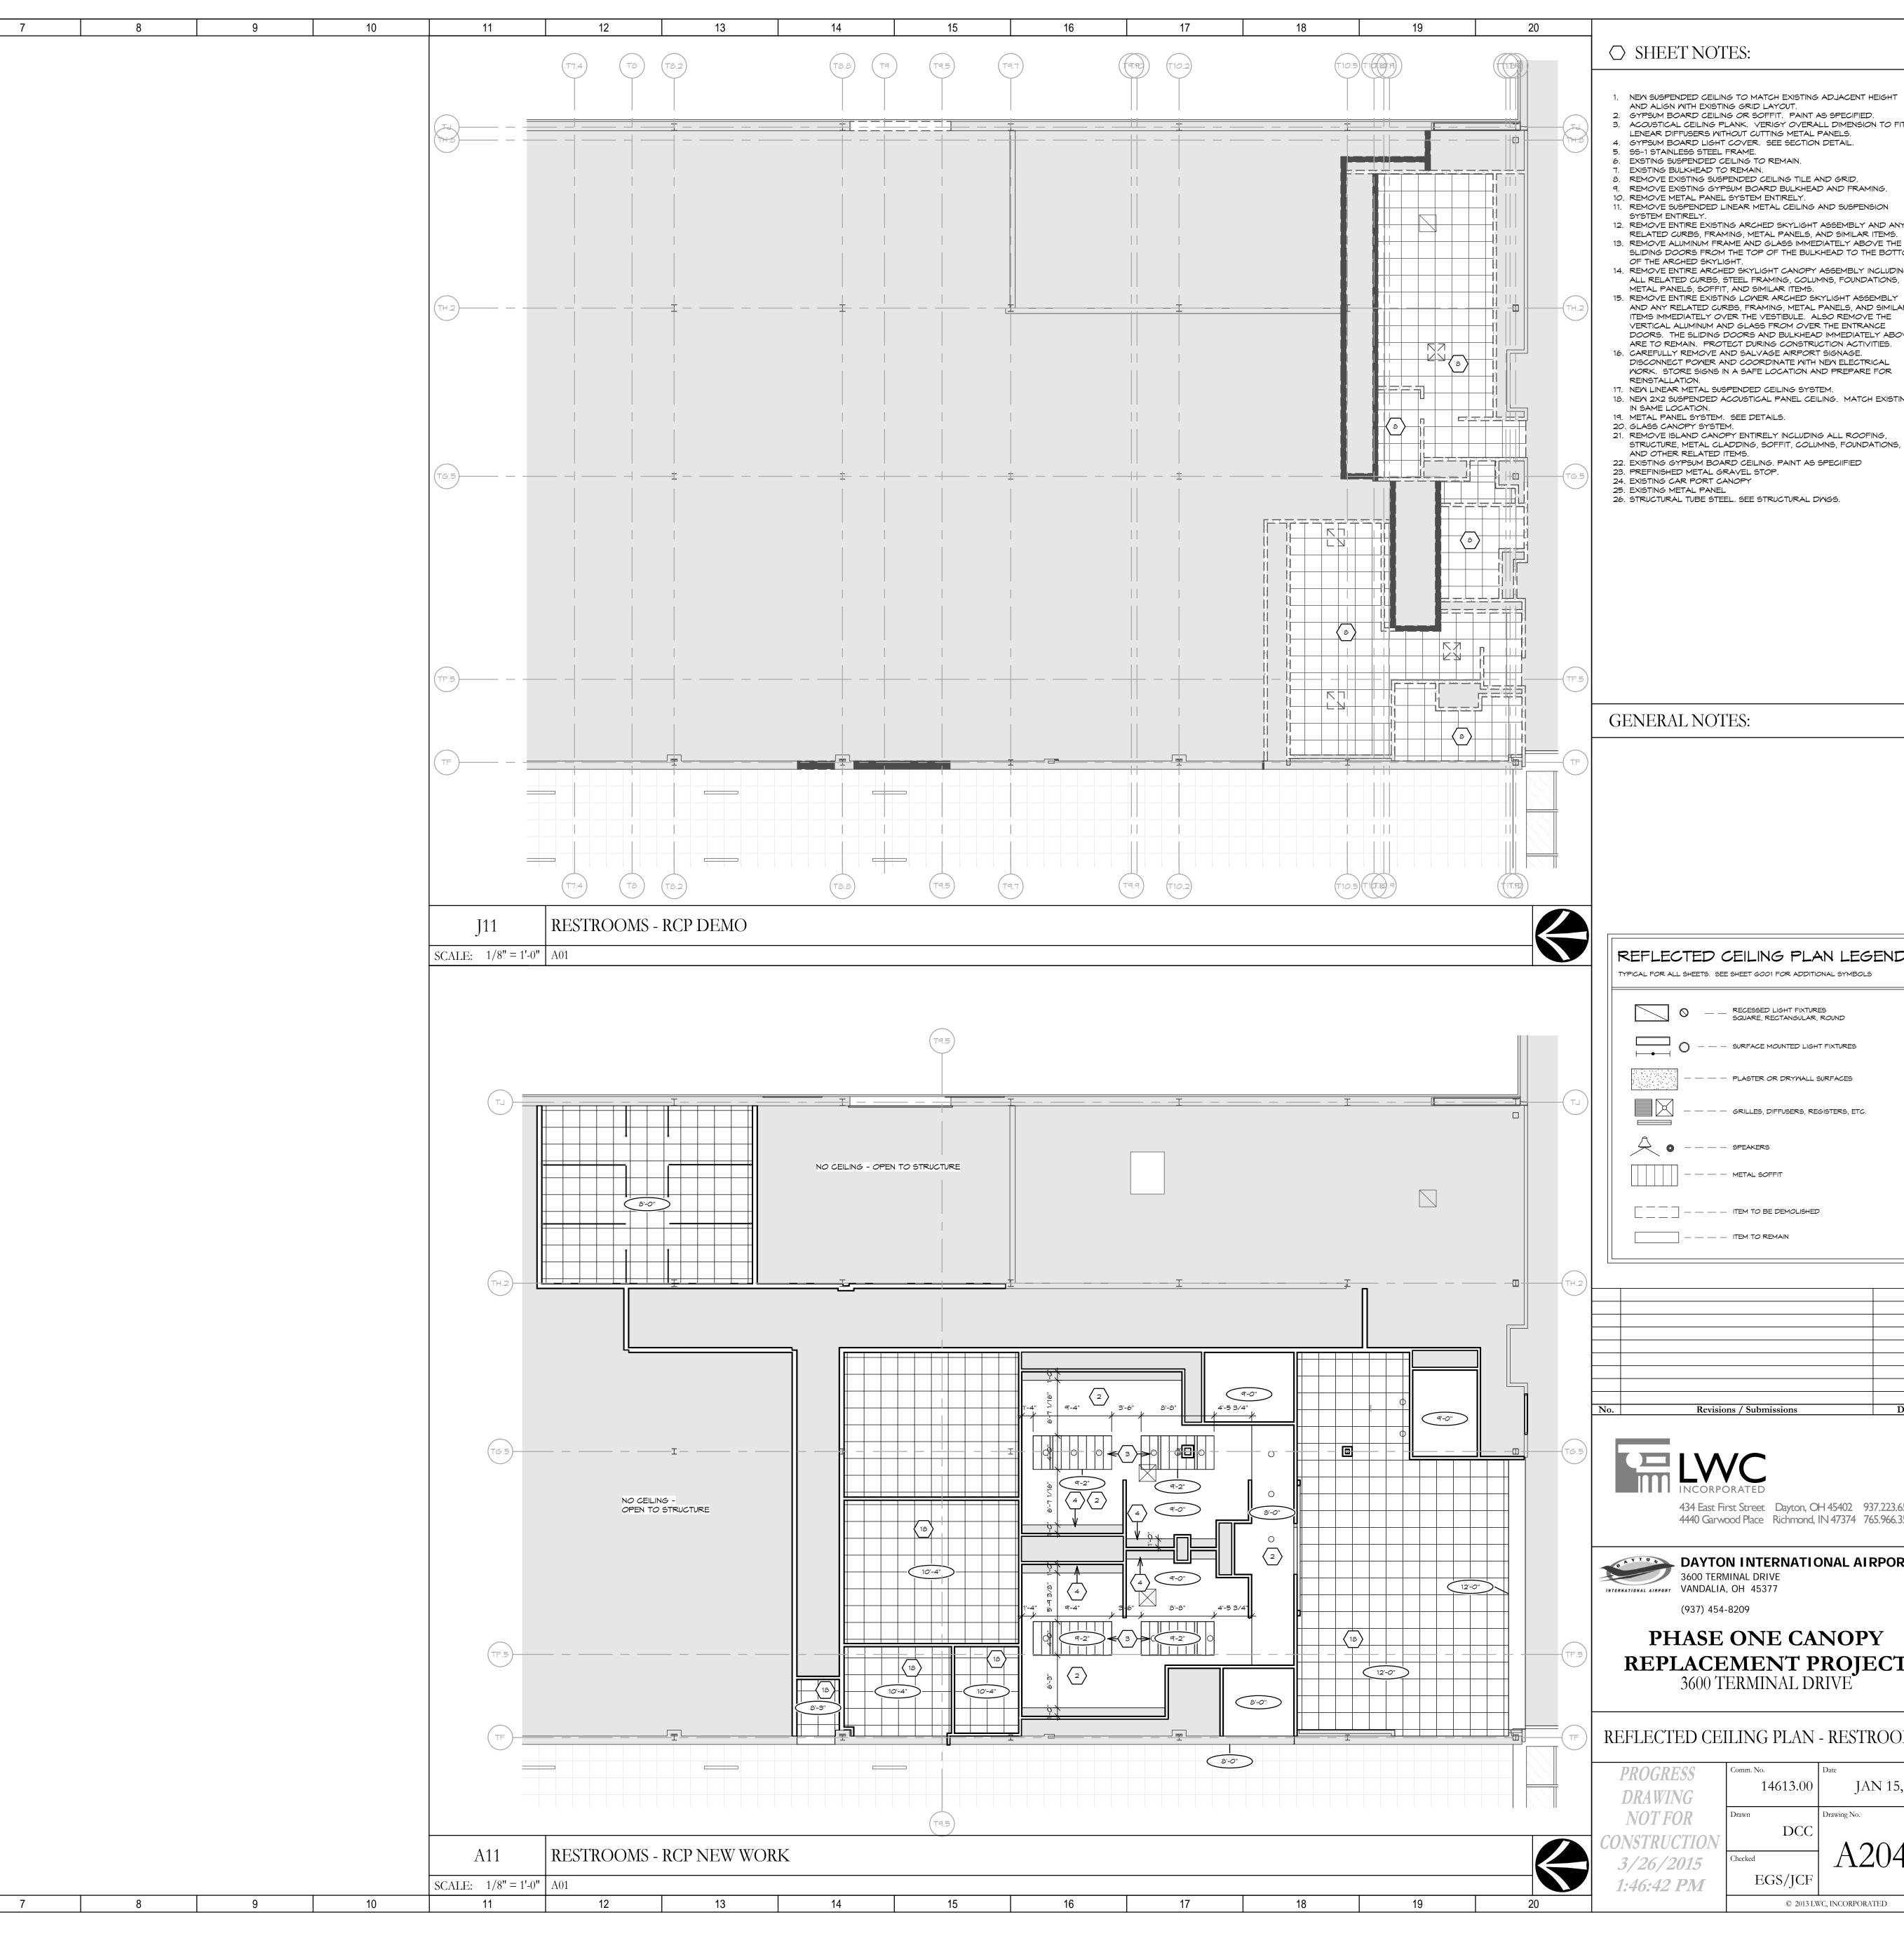
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	CEILING PLAN LEGEND BEE SHEET GOOI FOR ADDITIONAL SYMBOLS
0	 RECESSED LIGHT FIXTURES SQUARE, RECTANGULAR, ROUND
0	 - SURFACE MOUNTED LIGHT FIXTURES
	 - PLASTER OR DRYWALL SURFACES
_	 - GRILLES, DIFFUSERS, REGISTERS, ETC.
_	 - SPEAKERS
] –	 - METAL SOFFIT
] —	 - ITEM TO BE DEMOLISHED
] —	 — ITEM TO REMAIN



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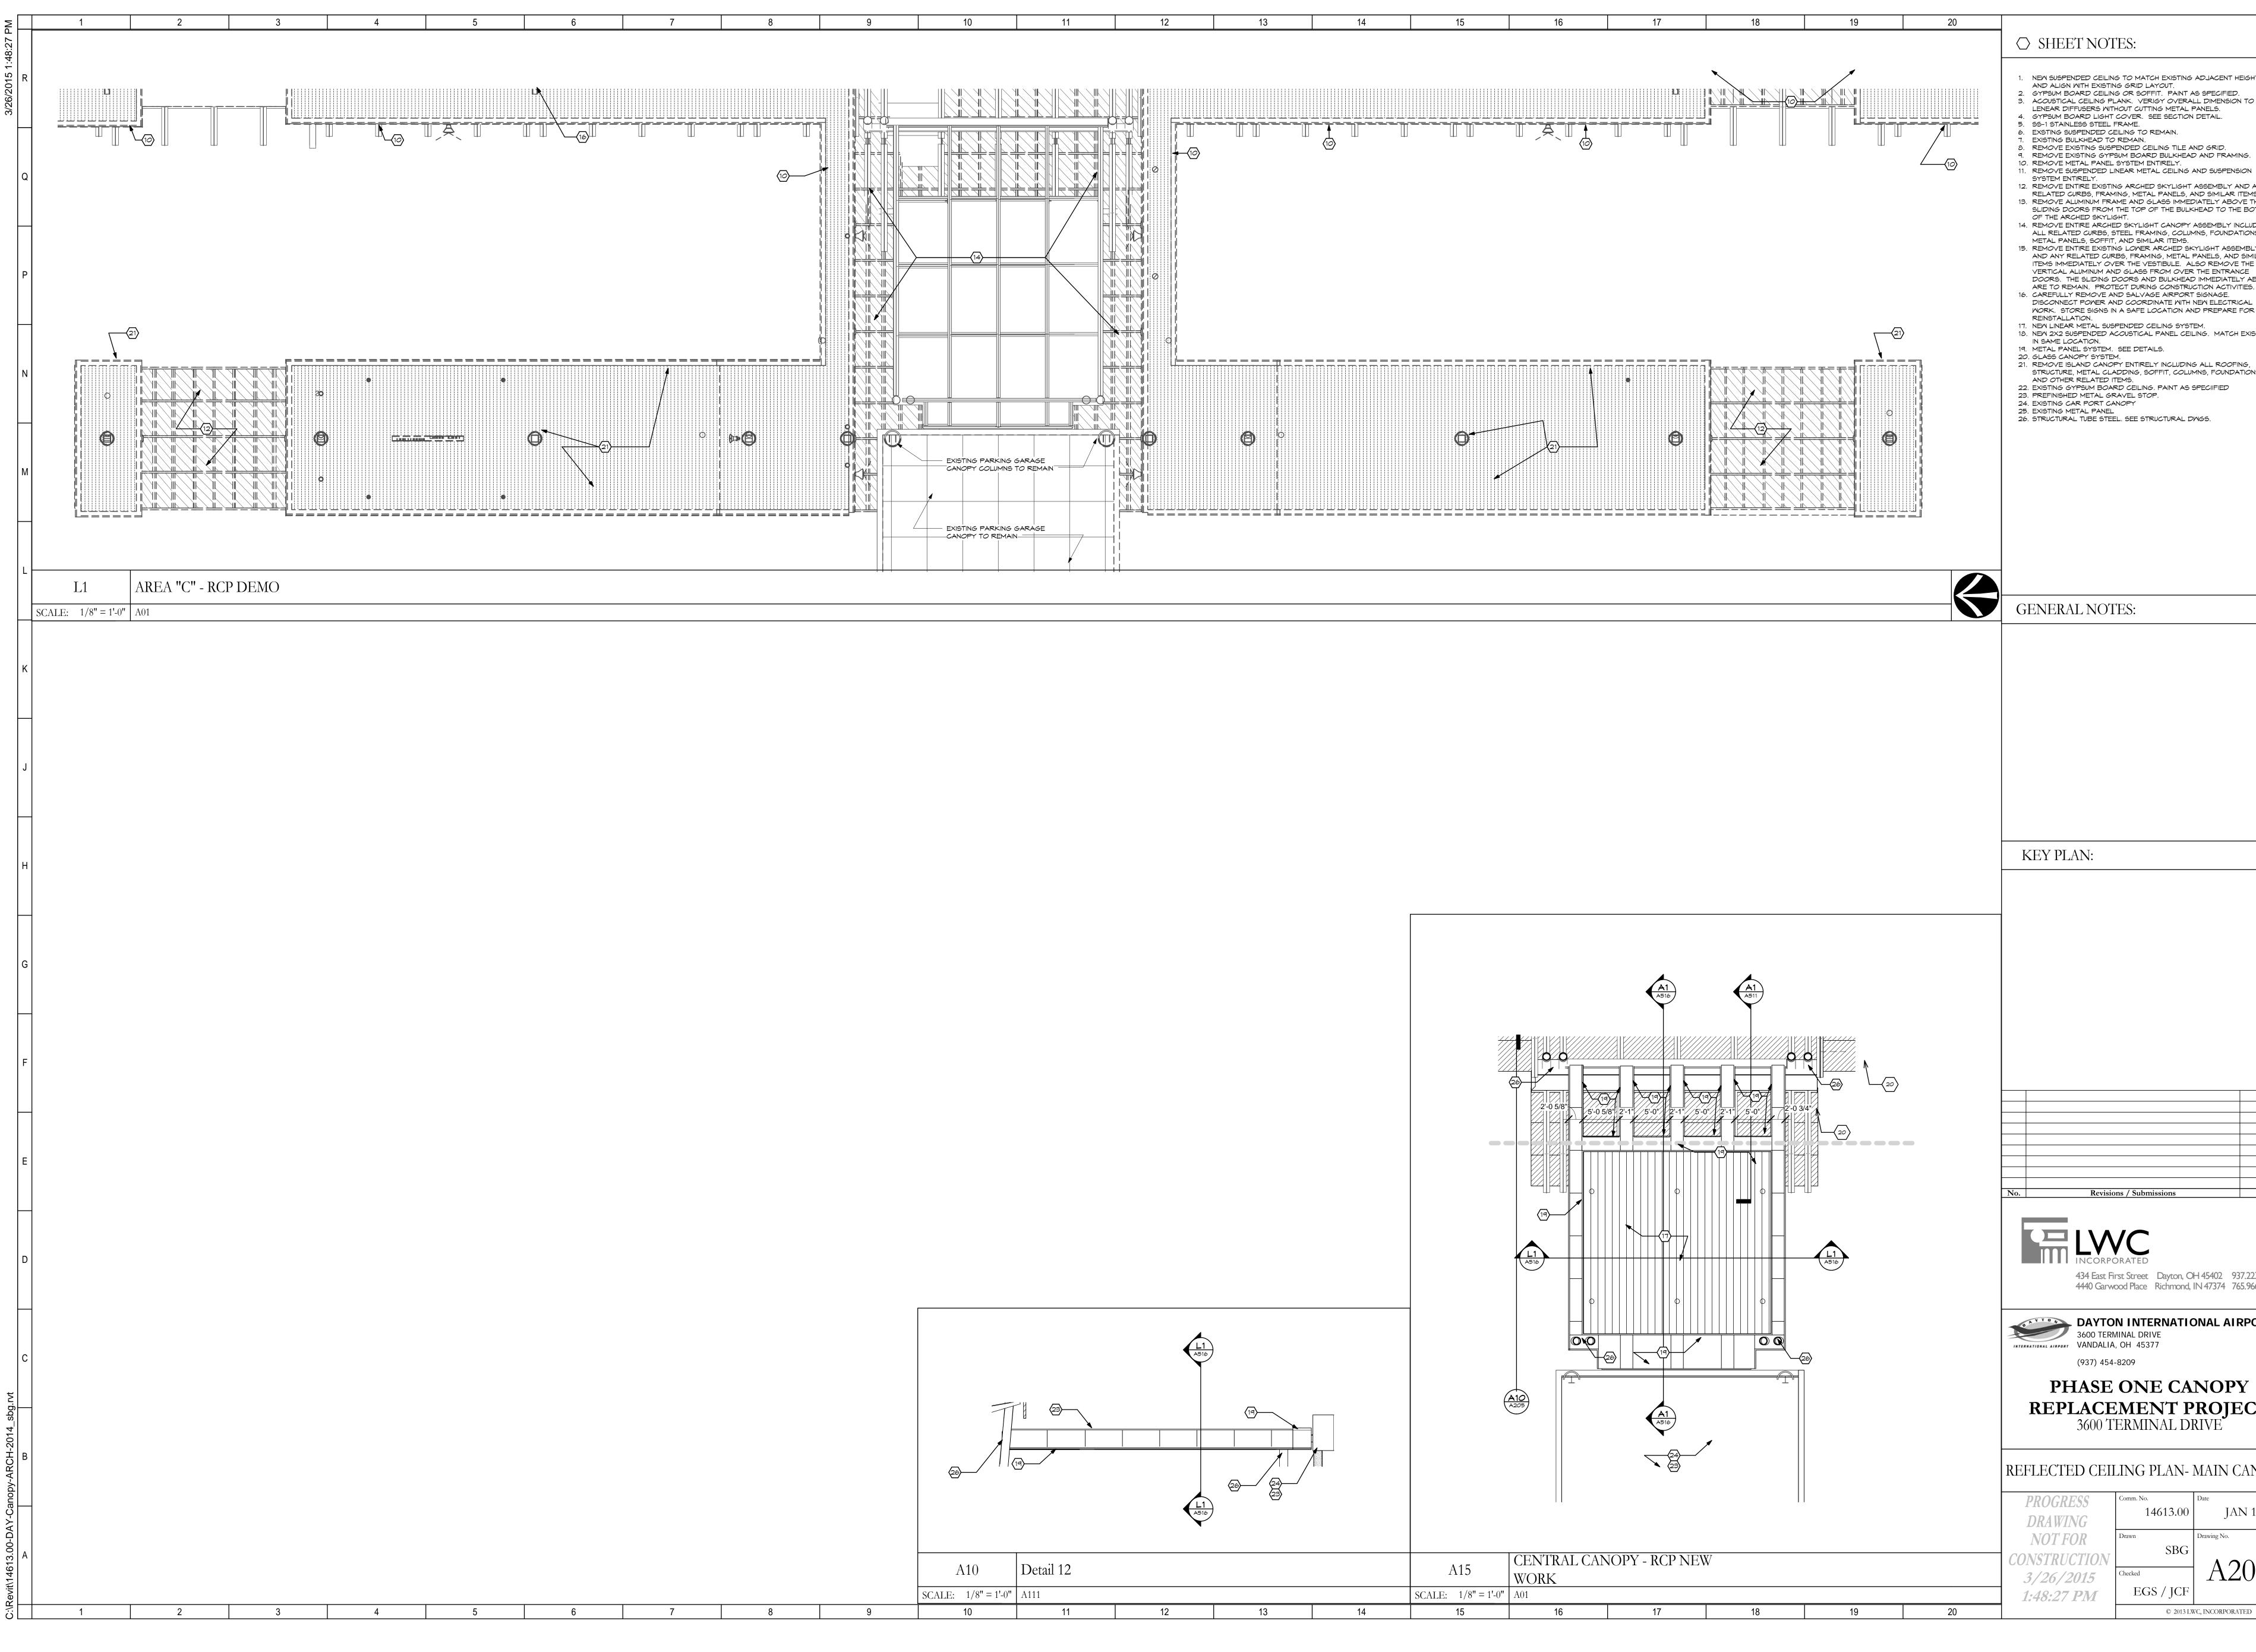
AND ALIGN WITH EXISTING GRID LAYOUT. 2. GYPSUM BOARD CEILING OR SOFFIT. PAINT AS SPECIFIED. 3. ACOUSTICAL CEILING PLANK. VERIGY OVERALL DIMENSION TO FIT ACCUSTICAL CLIENCE FEARLY VERICE OVERALE DIMENSION
 LENEAR DIFFUSERS WITHOUT CUTTING METAL PANELS.
 GYPSUM BOARD LIGHT COVER. SEE SECTION DETAIL.
 SS-1 STAINLESS STEEL FRAME. 6. EXSTING SUSPENDED CEILING TO REMAIN. 7. EXISTING BULKHEAD TO REMAIN. 8. REMOVE EXISTING SUSPENDED CEILING TILE AND GRID. 9. REMOVE EXISTING GYPSUM BOARD BULKHEAD AND FRAMING. 10. REMOVE METAL PANEL SYSTEM ENTIRELY. 11. REMOVE SUSPENDED LINEAR METAL CEILING AND SUSPENSION 12. REMOVE ENTIRE EXISTING ARCHED SKYLIGHT ASSEMBLY AND ANY RELATED CURBS, FRAMING, METAL PANELS, AND SIMILAR ITEMS. 13. REMOVE ALUMINUM FRAME AND GLASS IMMEDIATELY ABOVE THE SLIDING DOORS FROM THE TOP OF THE BULKHEAD TO THE BOTTOM OF THE ARCHED SKYLIGHT. 14. REMOVE ENTIRE ARCHED SKYLIGHT CANOPY ASSEMBLY INCLUDING ALL RELATED CURBS, STEEL FRAMING, COLUMNS, FOUNDATIONS, METAL PANELS, SOFFIT, AND SIMILAR ITEMS. 15. REMOVE ENTIRE EXISTING LOWER ARCHED SKYLIGHT ASSEMBLY AND ANY RELATED CURBS, FRAMING, METAL PANELS, AND SIMILAR ITEMS IMMEDIATELY OVER THE VESTIBULE. ALSO REMOVE THE VERTICAL ALUMINUM AND GLASS FROM OVER THE ENTRANCE DOORS. THE SLIDING DOORS AND BULKHEAD IMMEDIATELY ABOVE ARE TO REMAIN. PROTECT DURING CONSTRUCTION ACTIVITIES. 16. CAREFULLY REMOVE AND SALVAGE AIRPORT SIGNAGE. DISCONNECT POWER AND COORDINATE WITH NEW ELECTRICAL WORK. STORE SIGNS IN A SAFE LOCATION AND PREPARE FOR 17. NEW LINEAR METAL SUSPENDED CEILING SYSTEM. 18. NEW 2X2 SUSPENDED ACOUSTICAL PANEL CEILING. MATCH EXISTING 19. METAL PANEL SYSTEM. SEE DETAILS. 21. REMOVE ISLAND CANOPY ENTIRELY INCLUDING ALL ROOFING, 21. REMOVE ISLAND CAROFT EINTREET INCLUDING ALL ROOTING, STRUCTURE, METAL CLADDING, SOFFIT, COLUMNS, FOUNDATIONS, AND OTHER RELATED ITEMS.
 22. EXISTING GYPSUM BOARD CEILING. PAINT AS SPECIFIED 23. PREFINISHED METAL GRAVEL STOP.

26. STRUCTURAL TUBE STEEL. SEE STRUCTURAL DWGS.

REFLECTED CEILING PLAN LEGEND TYPICAL FOR ALL SHEETS. SEE SHEET GOO1 FOR ADDITIONAL SYMBOLS _ RECESSED LIGHT FIXTURES SQUARE, RECTANGULAR, ROUND ---- PLASTER OR DRYWALL SURFACES ---- GRILLES, DIFFUSERS, REGISTERS, ETC. _____ ITEM TO REMAIN **Revisions / Submissions** Date INCORPORATED 434 East First StreetDayton, OH 45402937.223.65004440 Garwood PlaceRichmond, IN 47374765.966.3546 **DAYTON INTERNATIONAL AIRPORT** 3600 TERMINAL DRIVE VANDALIA, OH 45377 (937) 454-8209 PHASE ONE CANOPY **REPLACEMENT PROJECT** 3600 TERMINAL DRIVE **REFLECTED CEILING PLAN - RESTROOMS** lomm. No. 14613.00 JAN 15, 2015 Drawing No. DCC A204

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1. NEW SUSPENDED CEILING TO MATCH EXISTING ADJACENT HEIGHT AND ALIGN WITH EXISTING GRID LAYOUT.
 GYPSUM BOARD CEILING OR SOFFIT. PAINT AS SPECIFIED.
 ACOUSTICAL CEILING PLANK. VERIGY OVERALL DIMENSION TO FIT

- LENEAR DIFFUSERS WITHOUT CUTTING METAL PANELS. 4. GYPSUM BOARD LIGHT COVER. SEE SECTION DETAIL.
- 6. EXSTING SUSPENDED CEILING TO REMAIN.
- 8. REMOVE EXISTING SUSPENDED CEILING TILE AND GRID.

9. REMOVE EXISTING GYPSUM BOARD BULKHEAD AND FRAMING. 10. REMOVE METAL PANEL SYSTEM ENTIRELY.

12. REMOVE ENTIRE EXISTING ARCHED SKYLIGHT ASSEMBLY AND ANY RELATED CURBS, FRAMING, METAL PANELS, AND SIMILAR ITEMS. 13. REMOVE ALUMINUM FRAME AND GLASS IMMEDIATELY ABOVE THE SLIDING DOORS FROM THE TOP OF THE BULKHEAD TO THE BOTTOM

14. REMOVE ENTIRE ARCHED SKYLIGHT CANOPY ASSEMBLY INCLUDING ALL RELATED CURBS, STEEL FRAMING, COLUMNS, FOUNDATIONS, METAL PANELS, SOFFIT, AND SIMILAR ITEMS. 15. REMOVE ENTIRE EXISTING LOWER ARCHED SKYLIGHT ASSEMBLY AND ANY RELATED CURBS, FRAMING, METAL PANELS, AND SIMILAR ITEMS IMMEDIATELY OVER THE VESTIBULE. ALSO REMOVE THE VERTICAL ALUMINUM AND GLASS FROM OVER THE ENTRANCE DOORS. THE SLIDING DOORS AND BULKHEAD IMMEDIATELY ABOVE ARE TO REMAIN. PROTECT DURING CONSTRUCTION ACTIVITIES. 16. CAREFULLY REMOVE AND SALVAGE AIRPORT SIGNAGE.

DISCONNECT POWER AND COORDINATE WITH NEW ELECTRICAL WORK. STORE SIGNS IN A SAFE LOCATION AND PREPARE FOR

NEW LINEAR METAL SUSPENDED CEILING SYSTEM.
 NEW 2X2 SUSPENDED ACOUSTICAL PANEL CEILING. MATCH EXISTING

21. REMOVE ISLAND CANOPY ENTIRELY INCLUDING ALL ROOFING, STRUCTURE, METAL CLADDING, SOFFIT, COLUMNS, FOUNDATIONS,

AND OTHER RELATED ITEMS. 22. EXISTING GYPSUM BOARD CEILING. PAINT AS SPECIIFIED

26. STRUCTURAL TUBE STEEL. SEE STRUCTURAL DWGS.

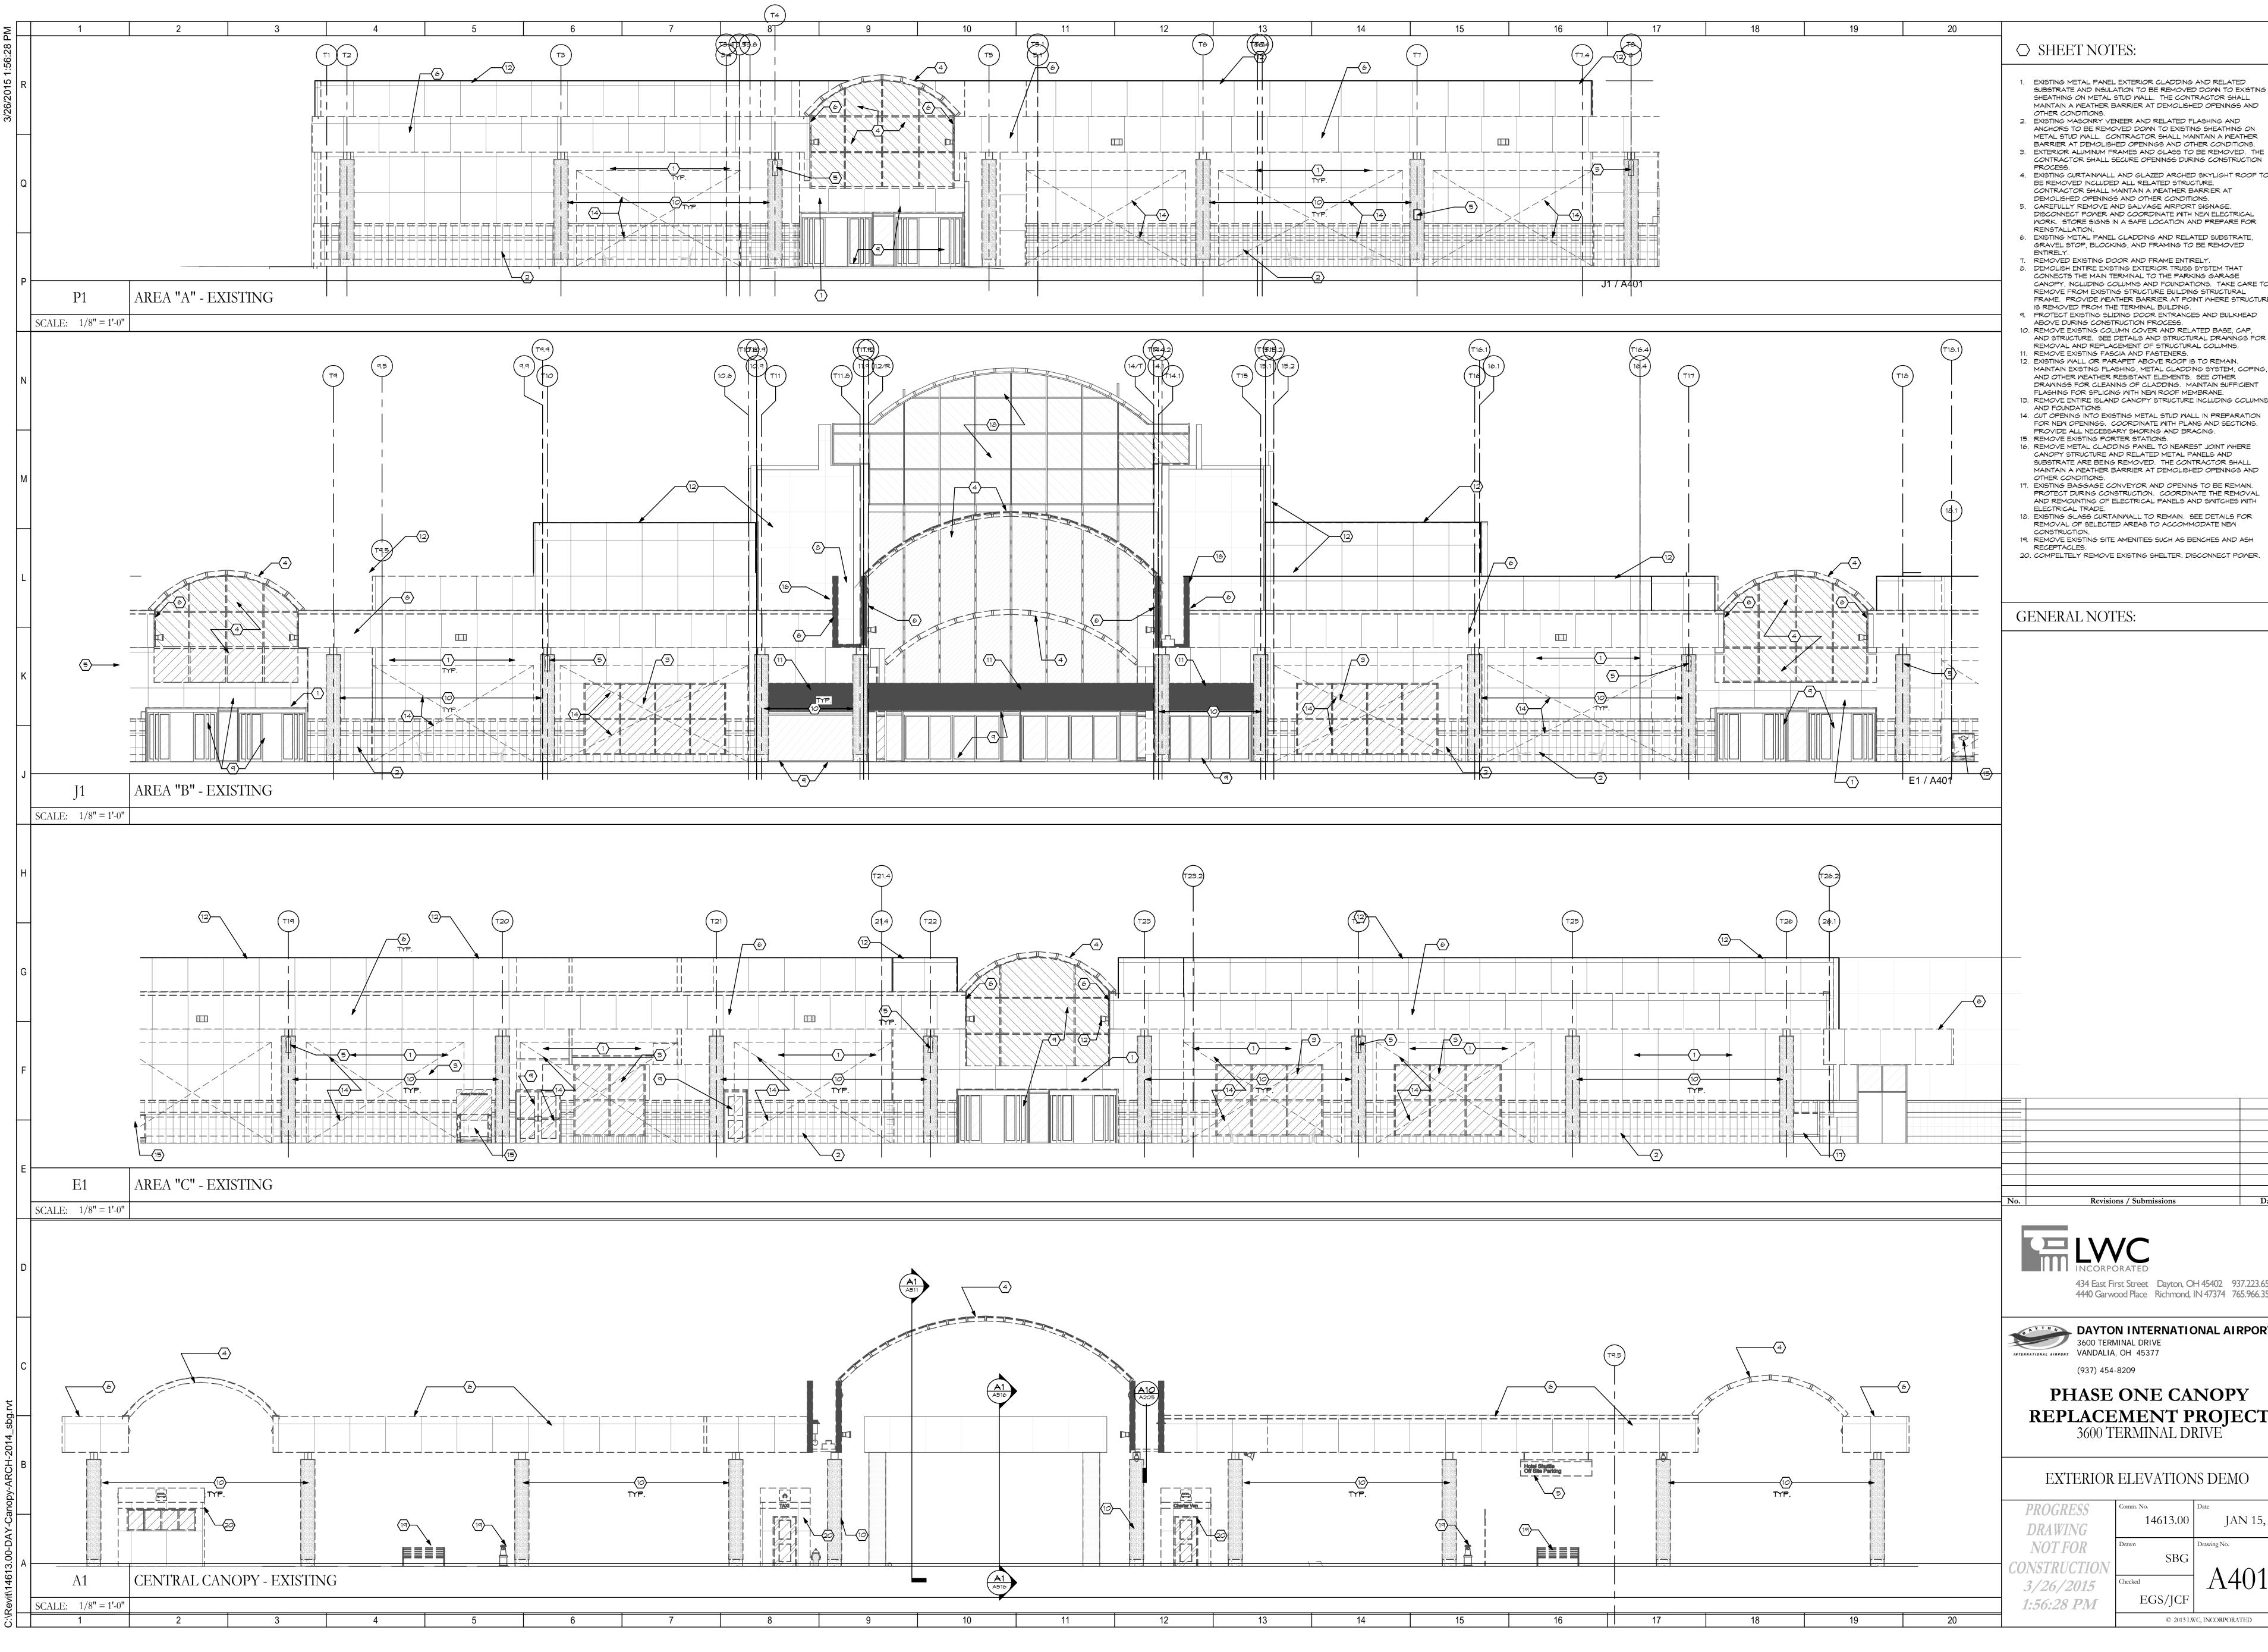
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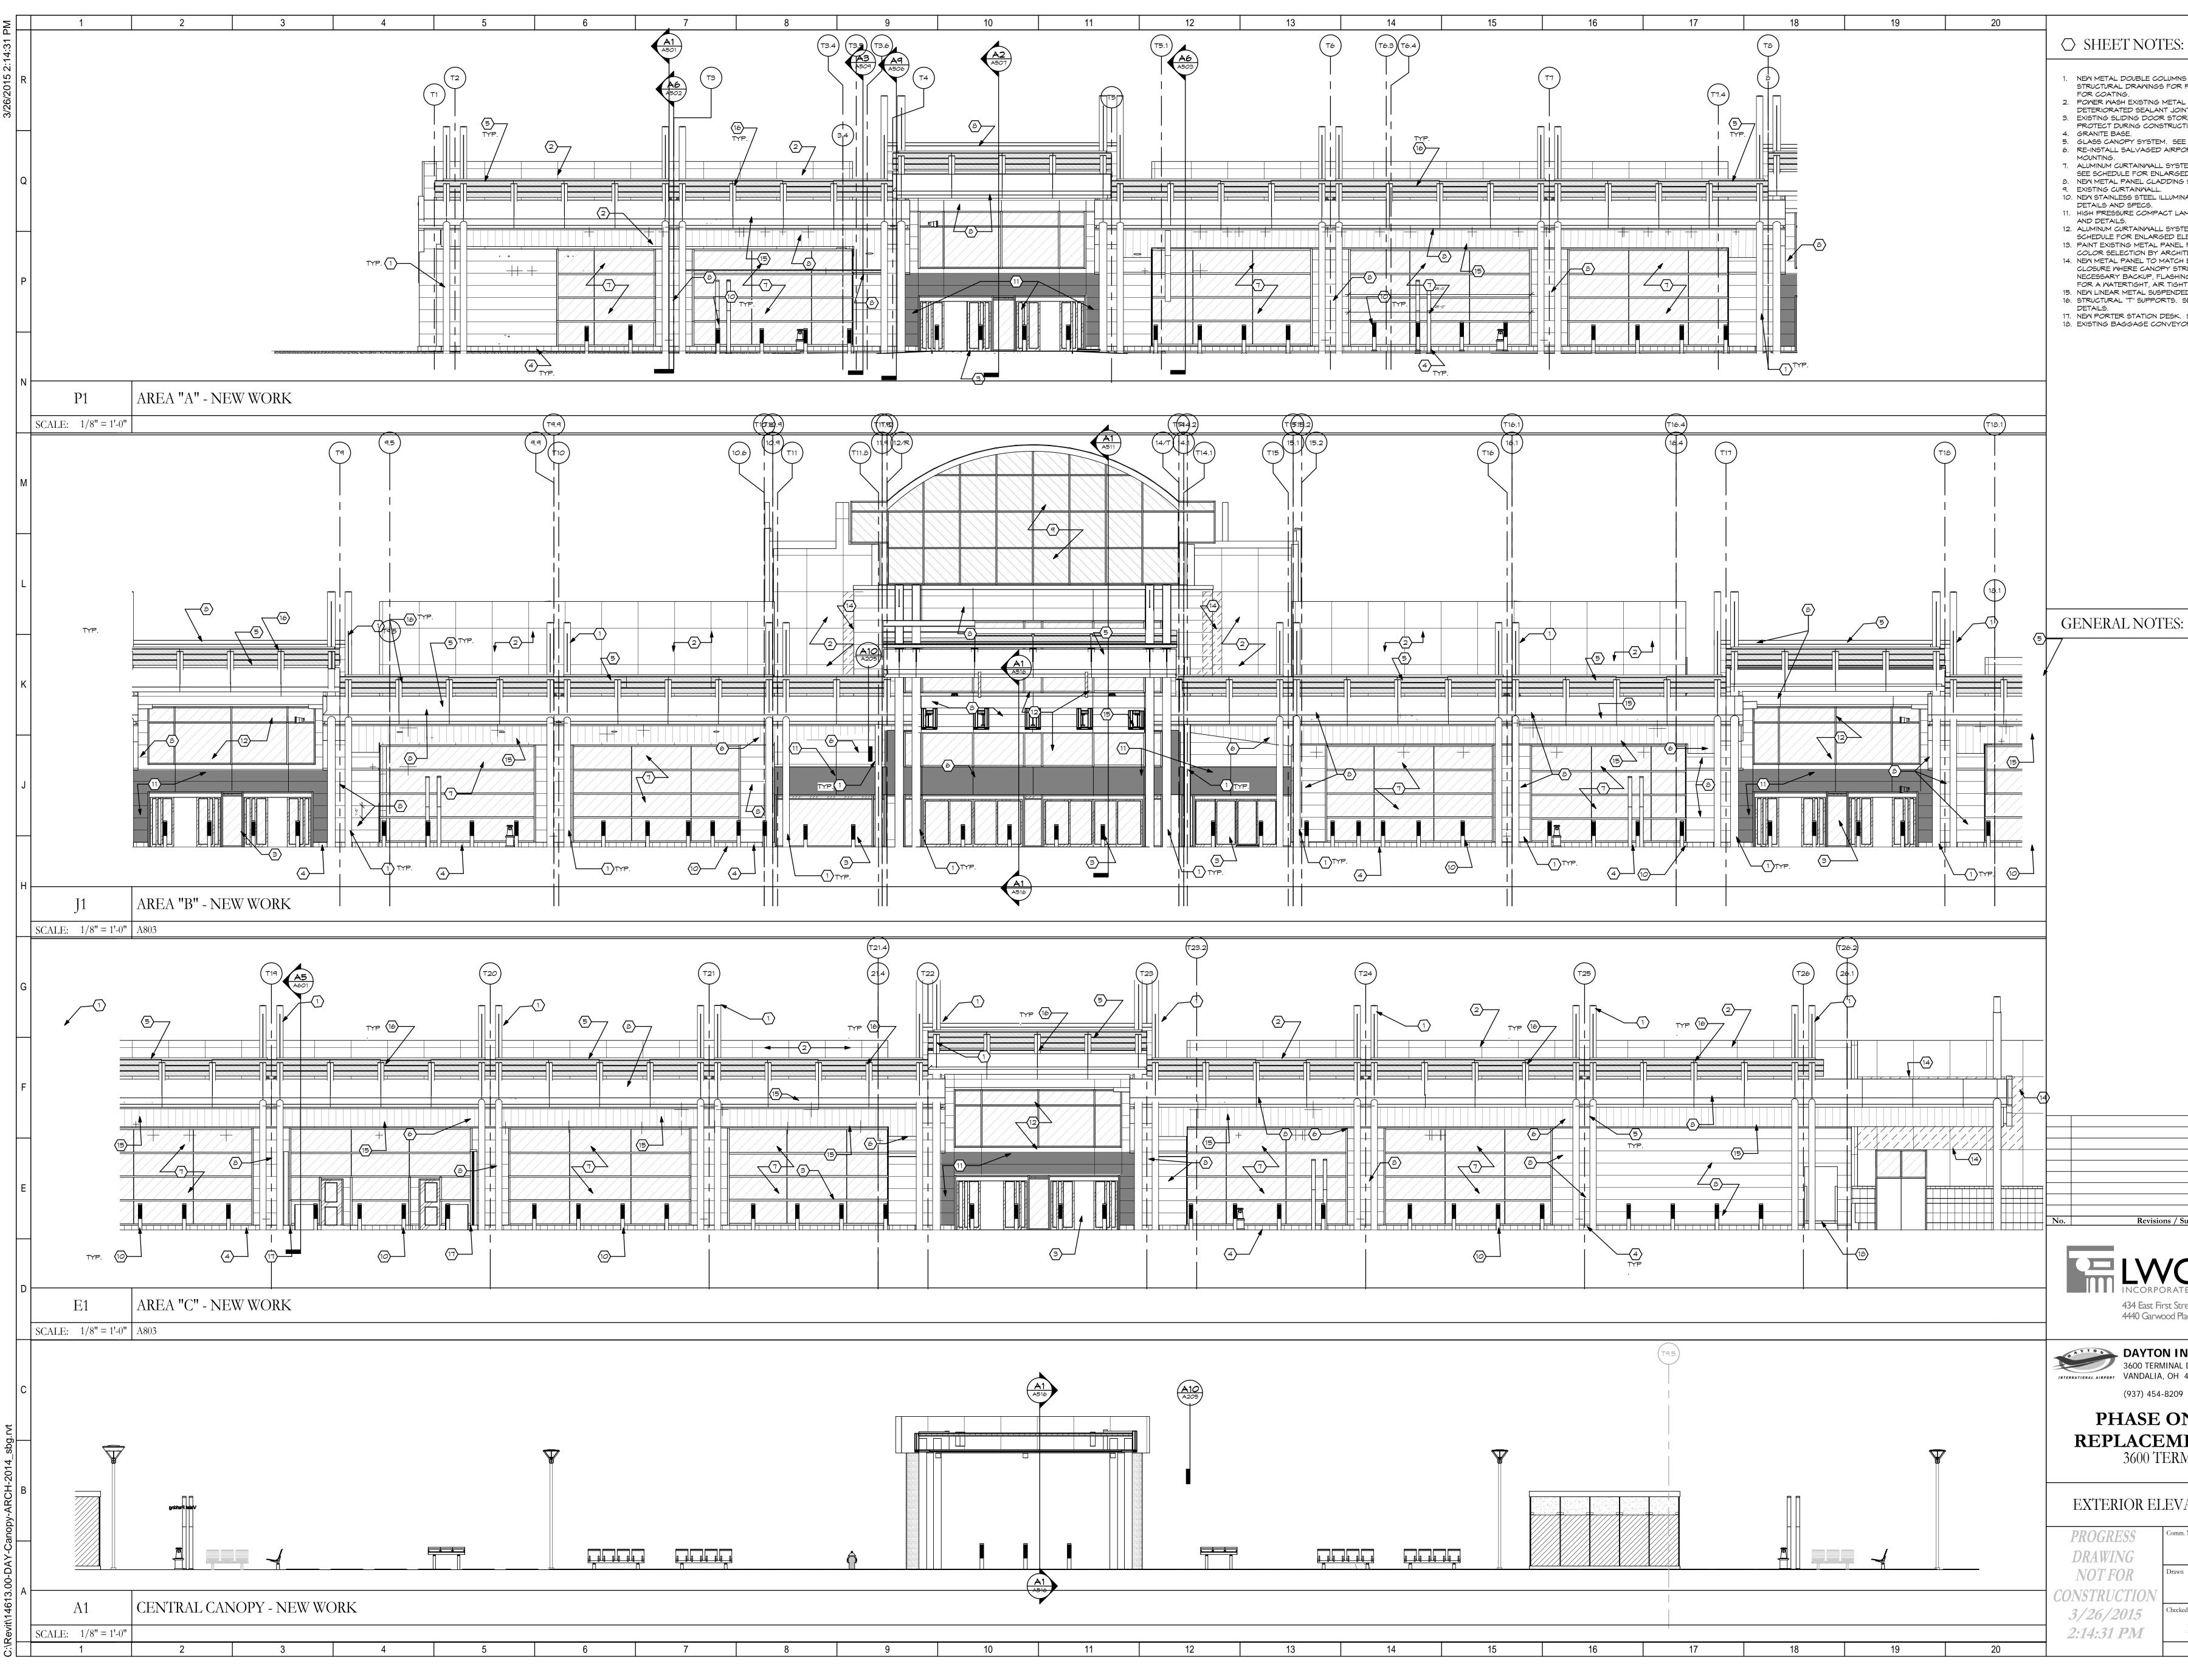
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SHEATHING ON METAL STUD WALL. THE CONTRACTOR SHALL MAINTAIN A WEATHER BARRIER AT DEMOLISHED OPENINGS AND 2. EXISTING MASONRY VENEER AND RELATED FLASHING AND ANCHORS TO BE REMOVED DOWN TO EXISTING SHEATHING ON METAL STUD WALL. CONTRACTOR SHALL MAINTAIN A WEATHER BARRIER AT DEMOLISHED OPENINGS AND OTHER CONDITIONS. 3. EXTERIOR ALUMINUM FRAMES AND GLASS TO BE REMOVED. THE CONTRACTOR SHALL SECURE OPENINGS DURING CONSTRUCTION 4. EXISTING CURTAINWALL AND GLAZED ARCHED SKYLIGHT ROOF TO BE REMOVED INCLUDED ALL RELATED STRUCTURE. CONTRACTOR SHALL MAINTAIN A WEATHER BARRIER AT DEMOLISHED OPENINGS AND OTHER CONDITIONS. 5. CAREFULLY REMOVE AND SALVAGE AIRPORT SIGNAGE. DISCONNECT POWER AND COORDINATE WITH NEW ELECTRICAL WORK. STORE SIGNS IN A SAFE LOCATION AND PREPARE FOR 6. EXISTING METAL PANEL CLADDING AND RELATED SUBSTRATE, GRAVEL STOP, BLOCKING, AND FRAMING TO BE REMOVED 7. REMOVED EXISTING DOOR AND FRAME ENTIRELY. 8. DEMOLISH ENTIRE EXISTING EXTERIOR TRUSS SYSTEM THAT CONNECTS THE MAIN TERMINAL TO THE PARKING GARAGE CANOPY, INCLUDING COLUMNS AND FOUNDATIONS. TAKE CARE TO REMOVE FROM EXISTING STRUCTURE BUILDING STRUCTURAL FRAME. PROVIDE WEATHER BARRIER AT POINT WHERE STRUCTURE IS REMOVED FROM THE TERMINAL BUILDING. PROTECT EXISTING SLIDING DOOR ENTRANCES AND BULKHEAD ABOVE DURING CONSTRUCTION PROCESS. 10. REMOVE EXISTING COLUMN COVER AND RELATED BASE, CAP, AND STRUCTURE. SEE DETAILS AND STRUCTURAL DRAWINGS FOR REMOVAL AND REPLACEMENT OF STRUCTURAL COLUMNS. 11. REMOVE EXISTING FASCIA AND FASTENERS. 12. EXISTING WALL OR PARAPET ABOVE ROOF IS TO REMAIN. MAINTAIN EXISTING FLASHING, METAL CLADDING SYSTEM, COPING, AND OTHER WEATHER RESISTANT ELEMENTS. SEE OTHER DRAWINGS FOR CLEANING OF CLADDING. MAINTAIN SUFFICIENT FLASHING FOR SPLICING WITH NEW ROOF MEMBRANE. 13. REMOVE ENTIRE ISLAND CANOPY STRUCTURE INCLUDING COLUMNS 14. CUT OPENING INTO EXISTING METAL STUD WALL IN PREPARATION FOR NEW OPENINGS. COORDINATE WITH PLANS AND SECTIONS. PROVIDE ALL NECESSARY SHORING AND BRACING. 15. REMOVE EXISTING PORTER STATIONS. 16. REMOVE METAL CLADDING PANEL TO NEAREST JOINT WHERE CANOPY STRUCTURE AND RELATED METAL PANELS AND SUBSTRATE ARE BEING REMOVED. THE CONTRACTOR SHALL MAINTAIN A WEATHER BARRIER AT DEMOLISHED OPENINGS AND 17. EXISTING BAGGAGE CONVEYOR AND OPENING TO BE REMAIN. PROTECT DURING CONSTRUCTION. COORDINATE THE REMOVAL AND REMOUNTING OF ELECTRICAL PANELS AND SWITCHES WITH 18. EXISTING GLASS CURTAINWALL TO REMAIN. SEE DETAILS FOR REMOVAL OF SELECTED AREAS TO ACCOMMODATE NEW 19. REMOVE EXISTING SITE AMENITIES SUCH AS BENCHES AND ASH 20. COMPELTELY REMOVE EXISTING SHELTER. DISCONNECT POWER.

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NEW METAL DOUBLE COLUMNS COATED WITH INTUMESCENT PAINT. SEE STRUCTURAL DRAWINGS FOR PLACEMENT AND DETAILING. SEE SPECS

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 EXISTING SLIDING DOOR STOREFRONT ENTRANCES TO REMAIN. PROTECT DURING CONSTRUCTION.

5. GLASS CANOPY SYSTEM. SEE DETAILS AND SPECS. 6. RE-INSTALL SALVAGED AIRPORT SIGNAGE. SEE DETAILS FOR

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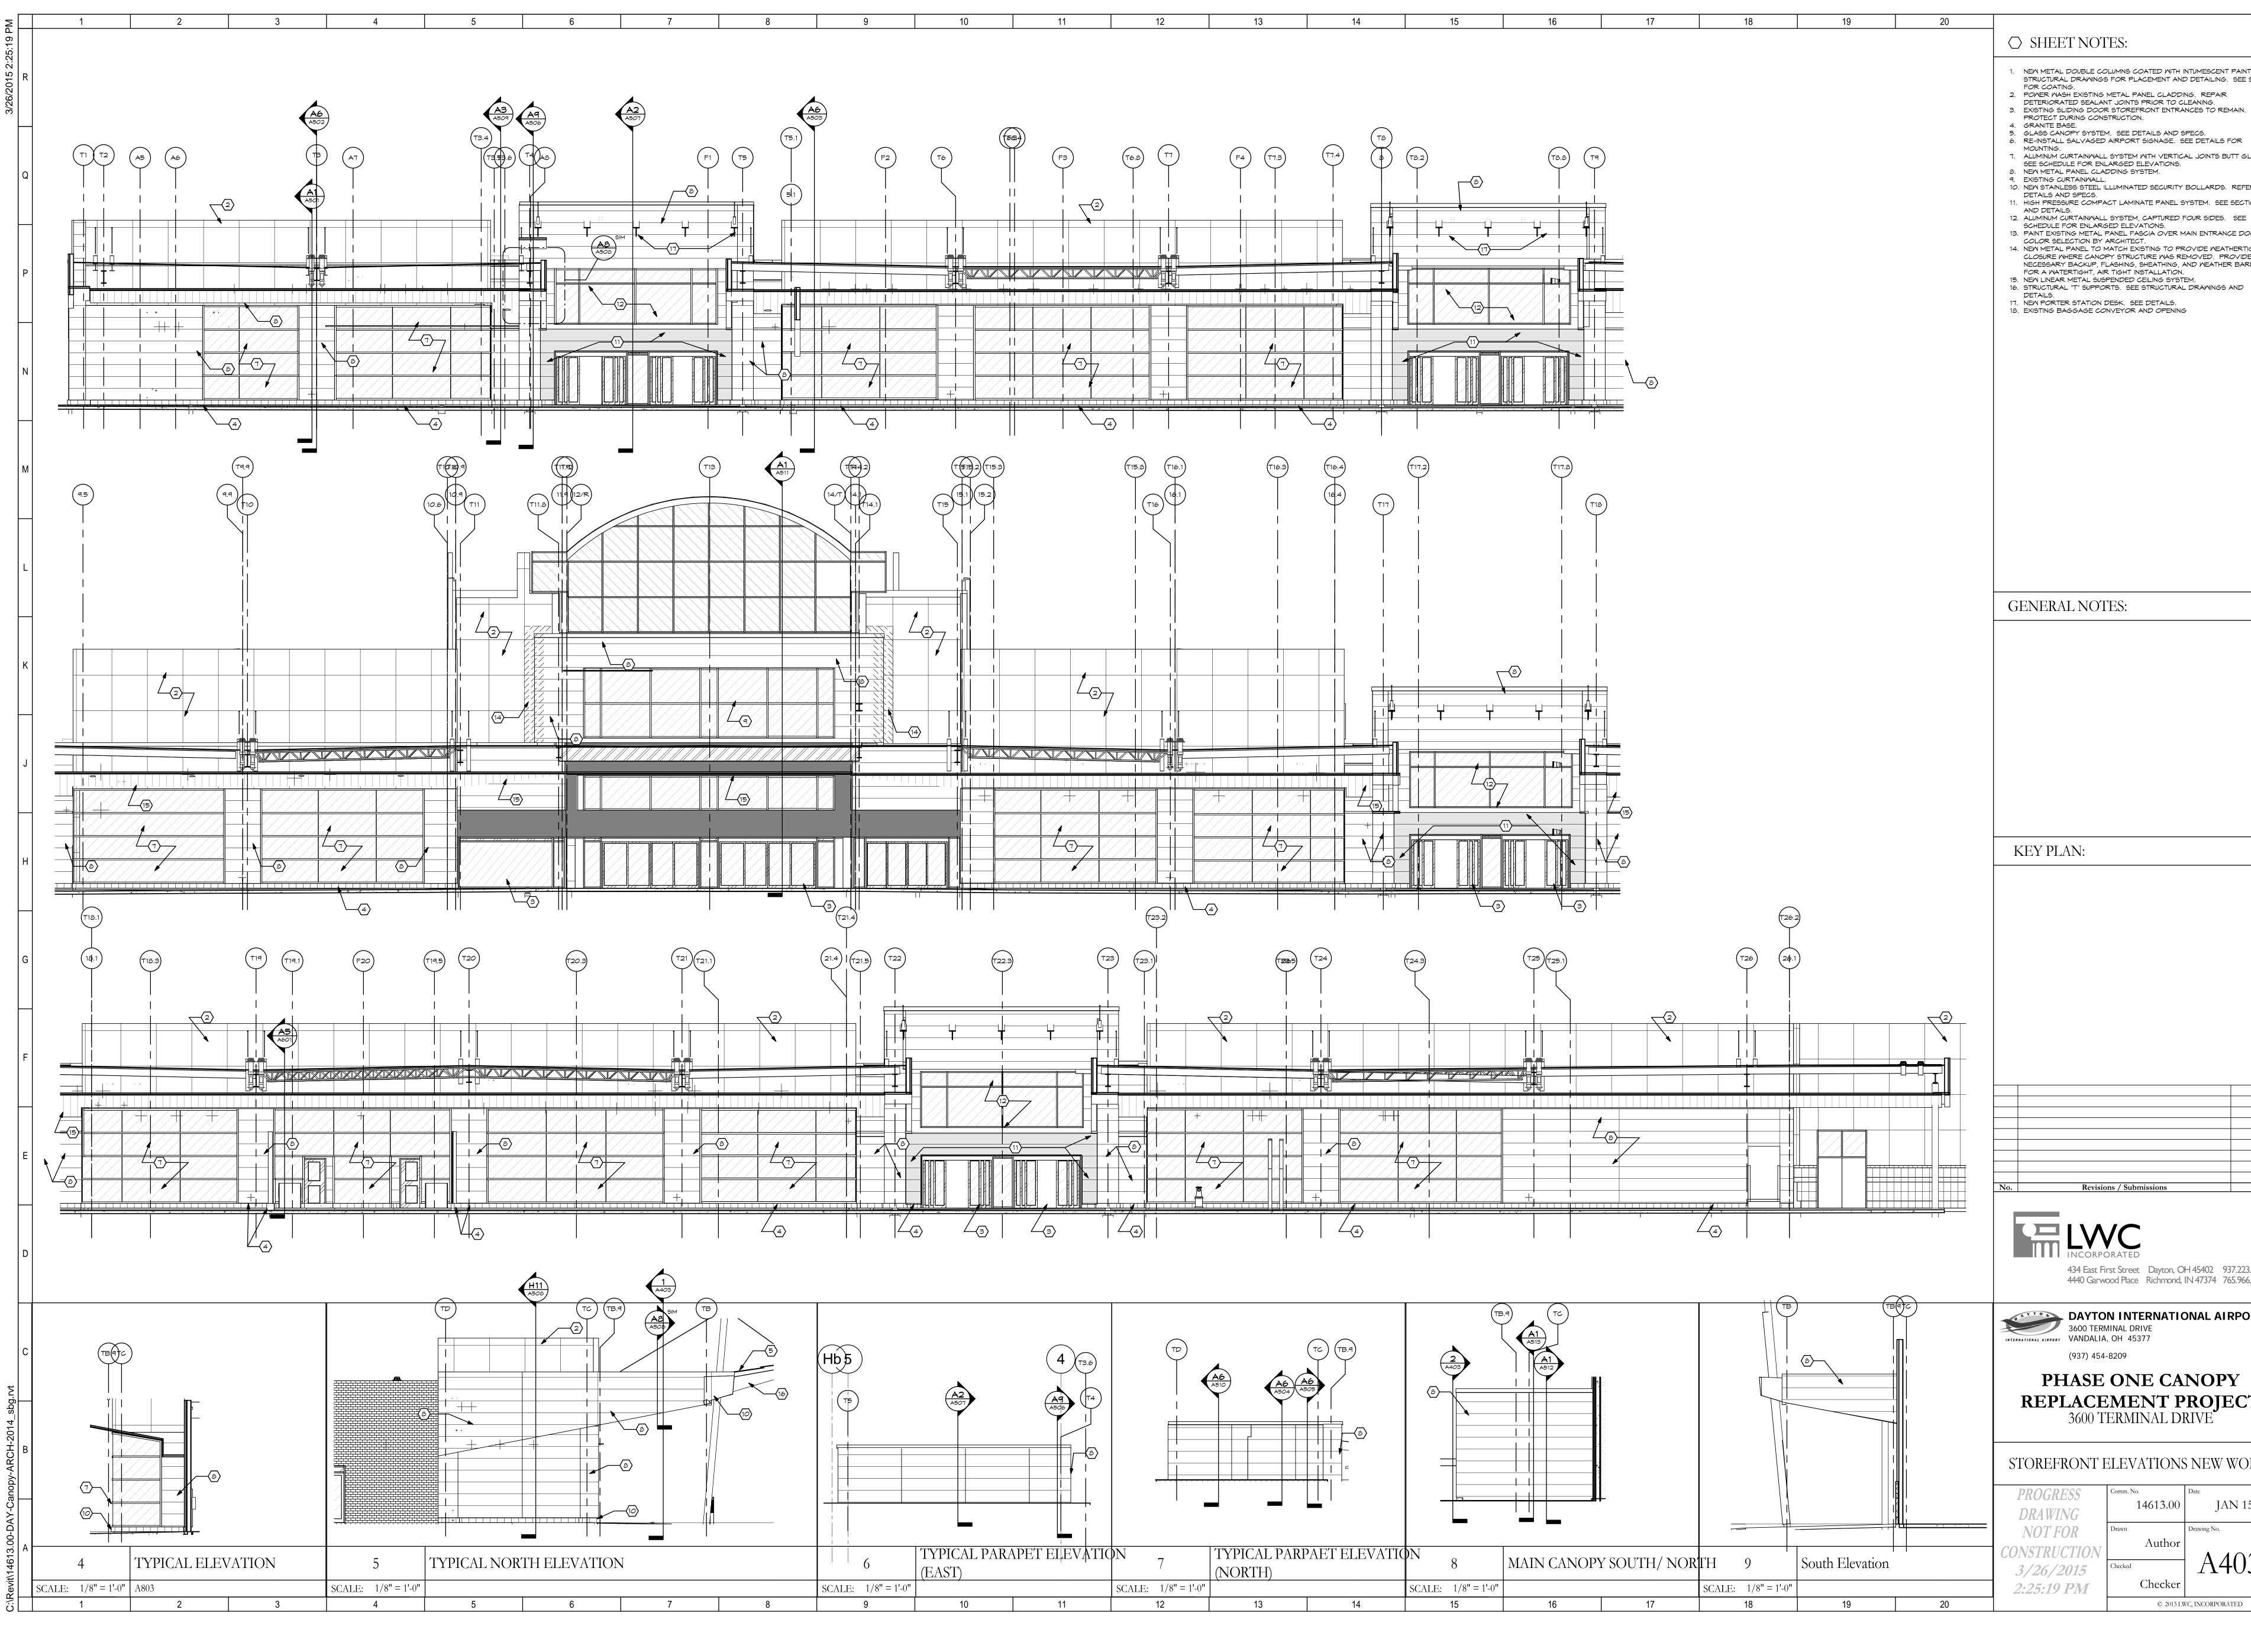
10. NEW STAINLESS STEEL ILLUMINATED SECURITY BOLLARDS. REFER TO 11. HIGH PRESSURE COMPACT LAMINATE PANEL SYSTEM. SEE SECTIONS

12. ALUMINUM CURTAINWALL SYSTEM, CAPTURED FOUR SIDES. SEE SCHEDULE FOR ENLARGED ELEVATIONS. 13. PAINT EXISTING METAL PANEL FASCIA OVER MAIN ENTRANCE DOORS. COLOR SELECTION BY ARCHITECT.

14. NEW METAL PANEL TO MATCH EXISTING TO PROVIDE WEATHERTIGHT CLOSURE WHERE CANOPY STRUCTURE WAS REMOVED. PROVIDE NECESSARY BACKUP, FLASHING, SHEATHING, AND WEATHER BARRIER FOR A WATERTIGHT, AIR TIGHT INSTALLATION. 15. NEW LINEAR METAL SUSPENDED CEILING SYSTEM. 16. STRUCTURAL "T" SUPPORTS. SEE STRUCTURAL DRAWINGS AND

17. NEW PORTER STATION DESK. SEE DETAILS. 18. EXISTING BAGGAGE CONVEYOR AND OPENING

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PROTECT DURING CONSTRUCTION. 5. GLASS CANOPY SYSTEM. SEE DETAILS AND SPECS.

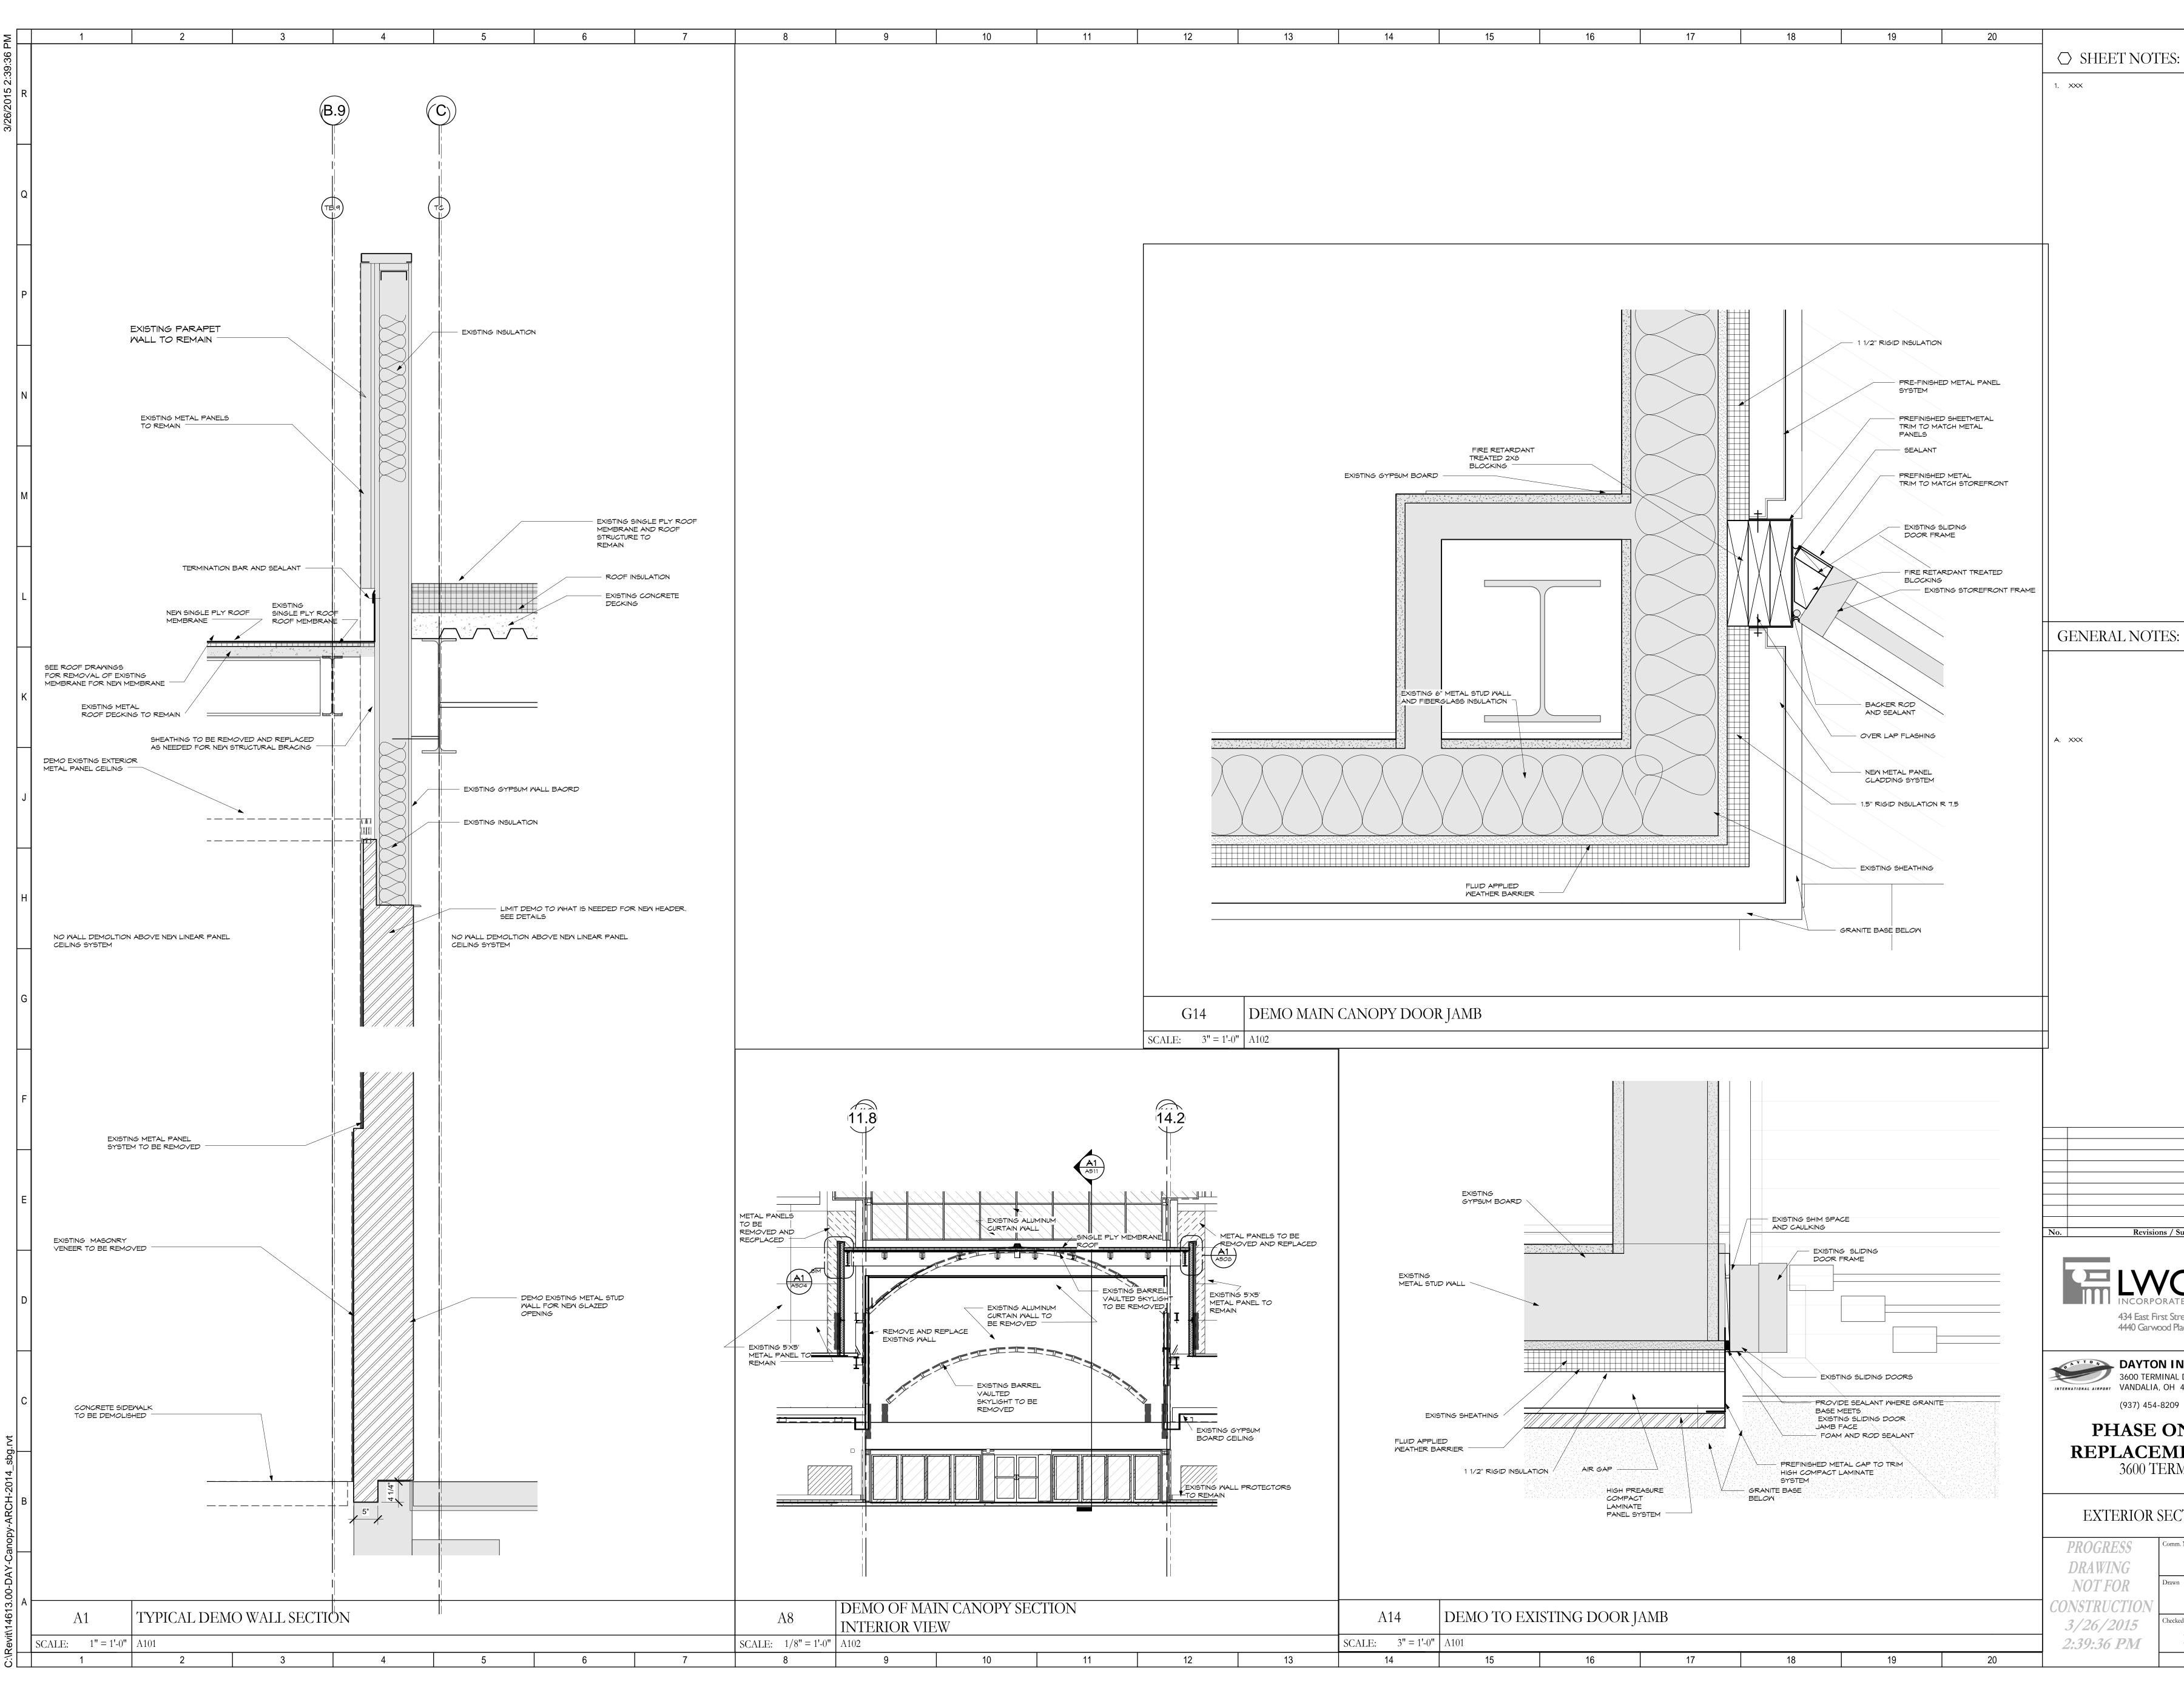
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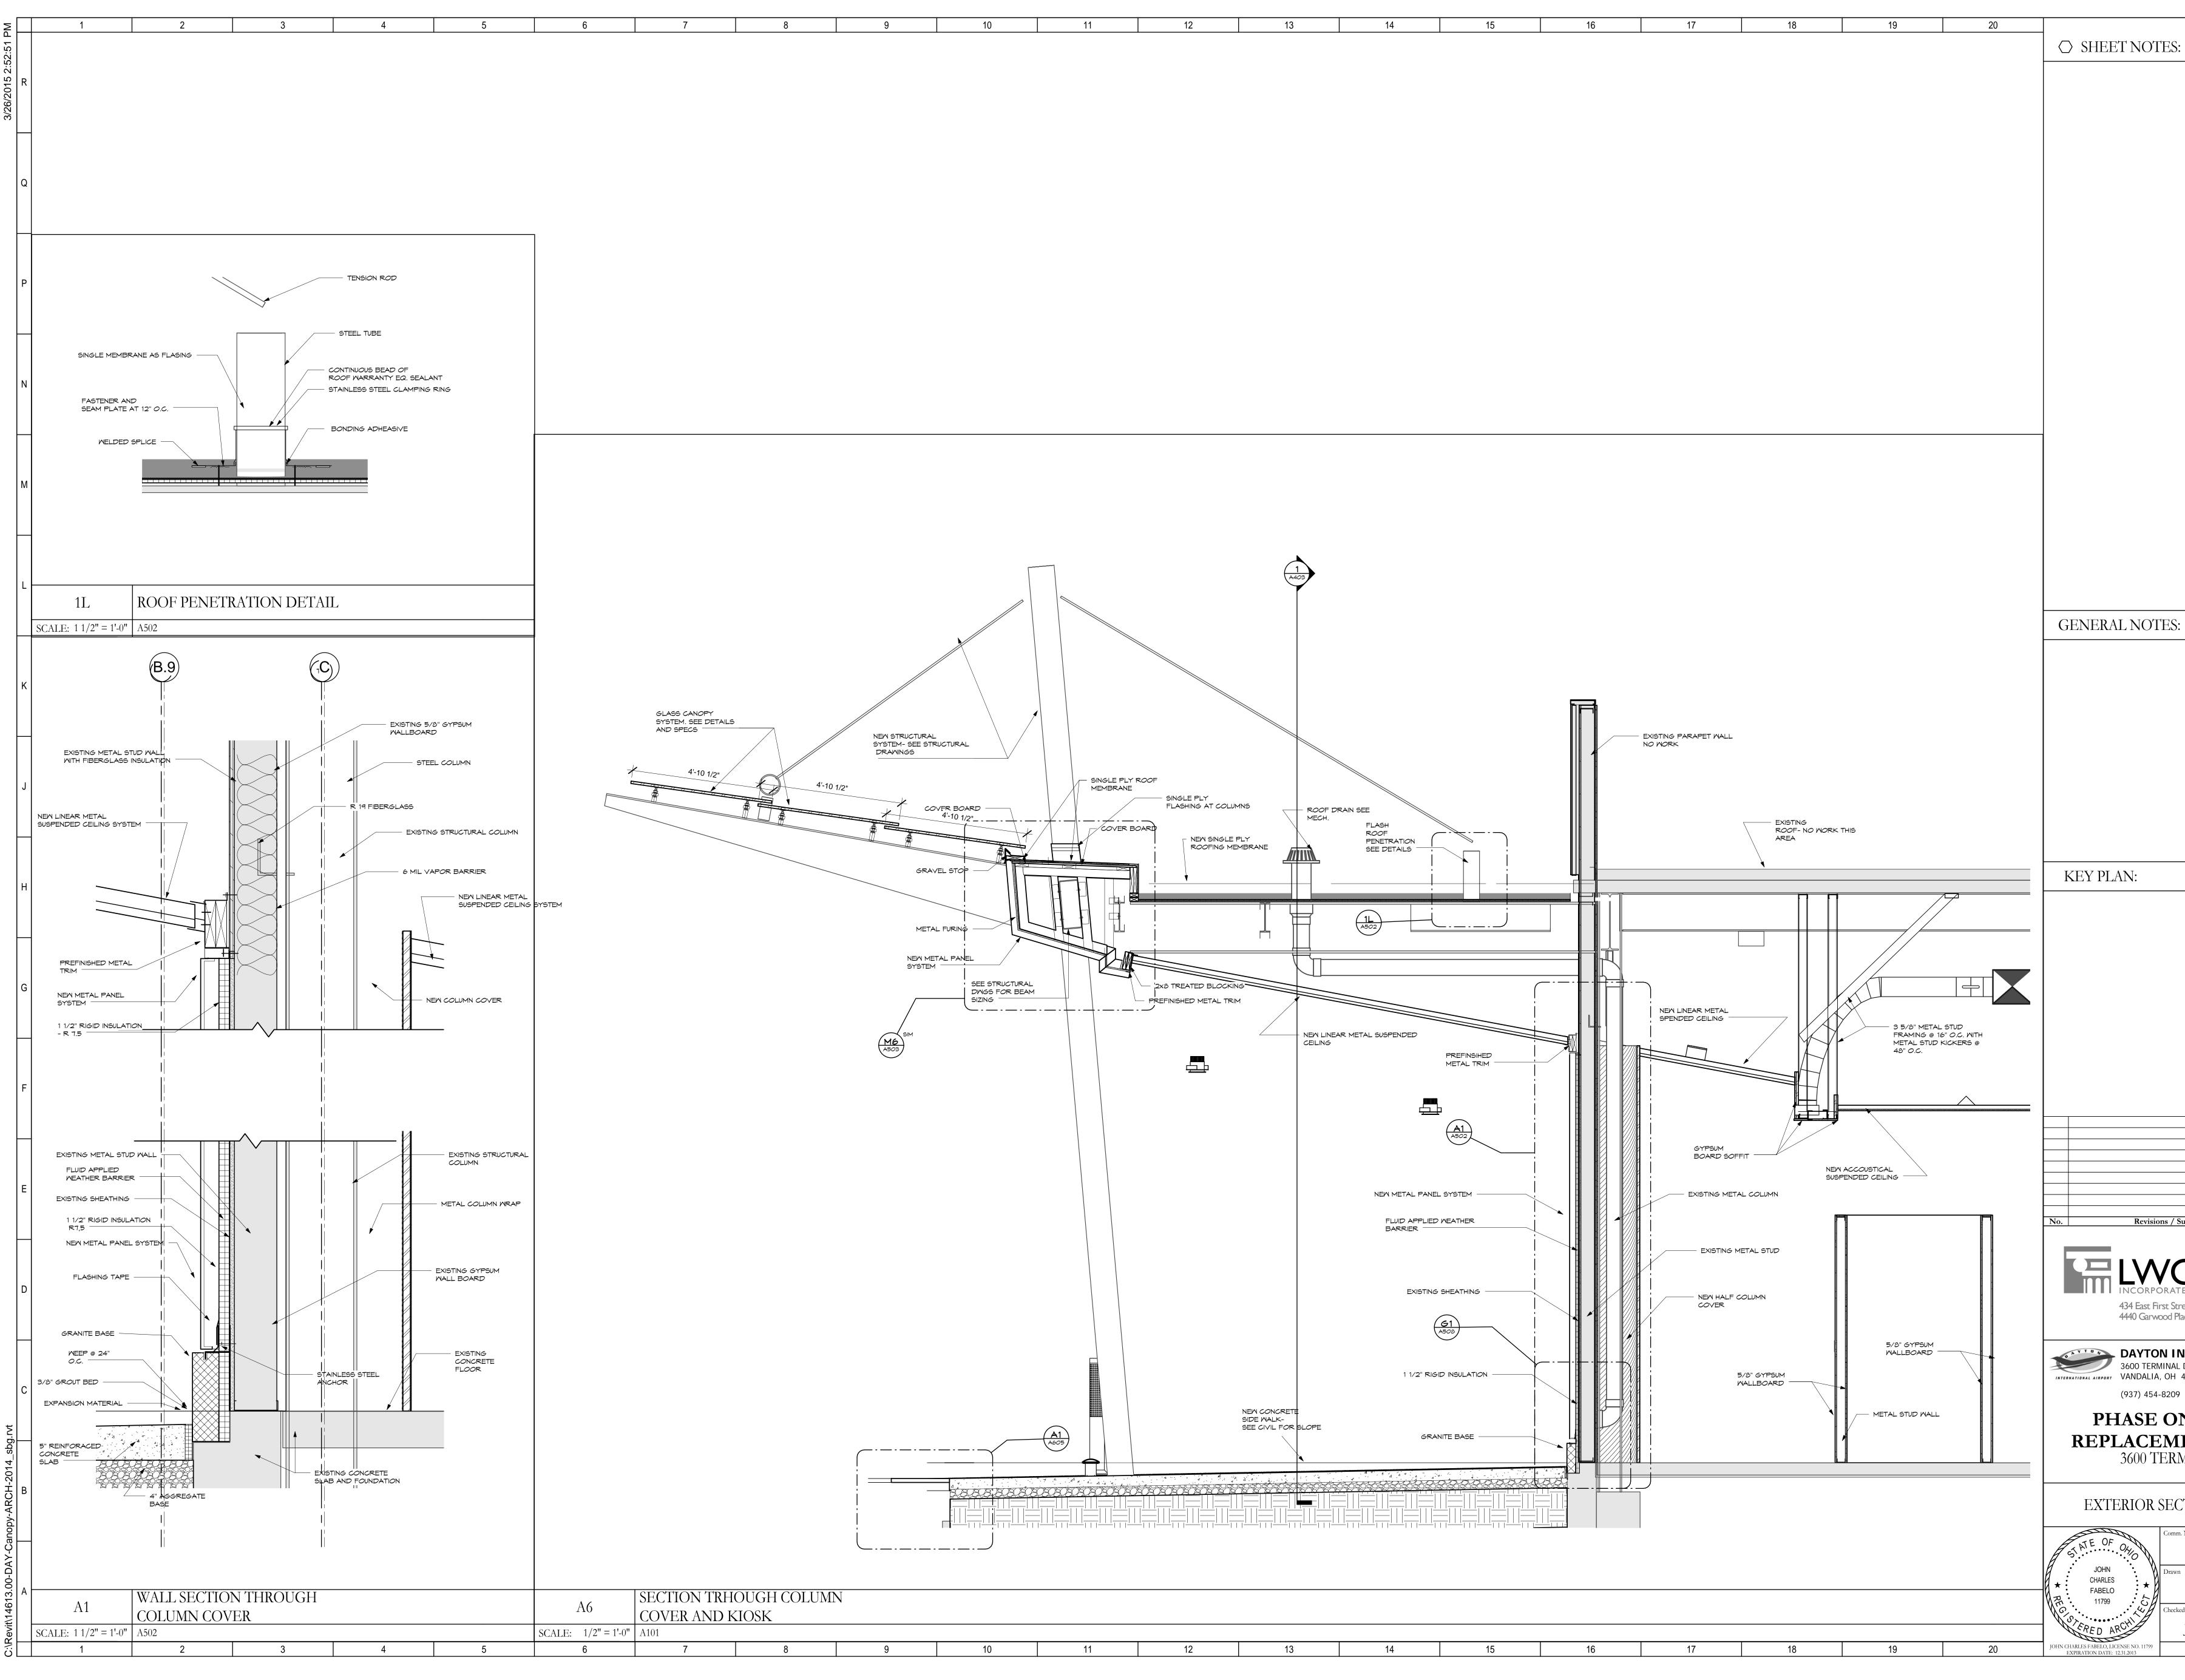
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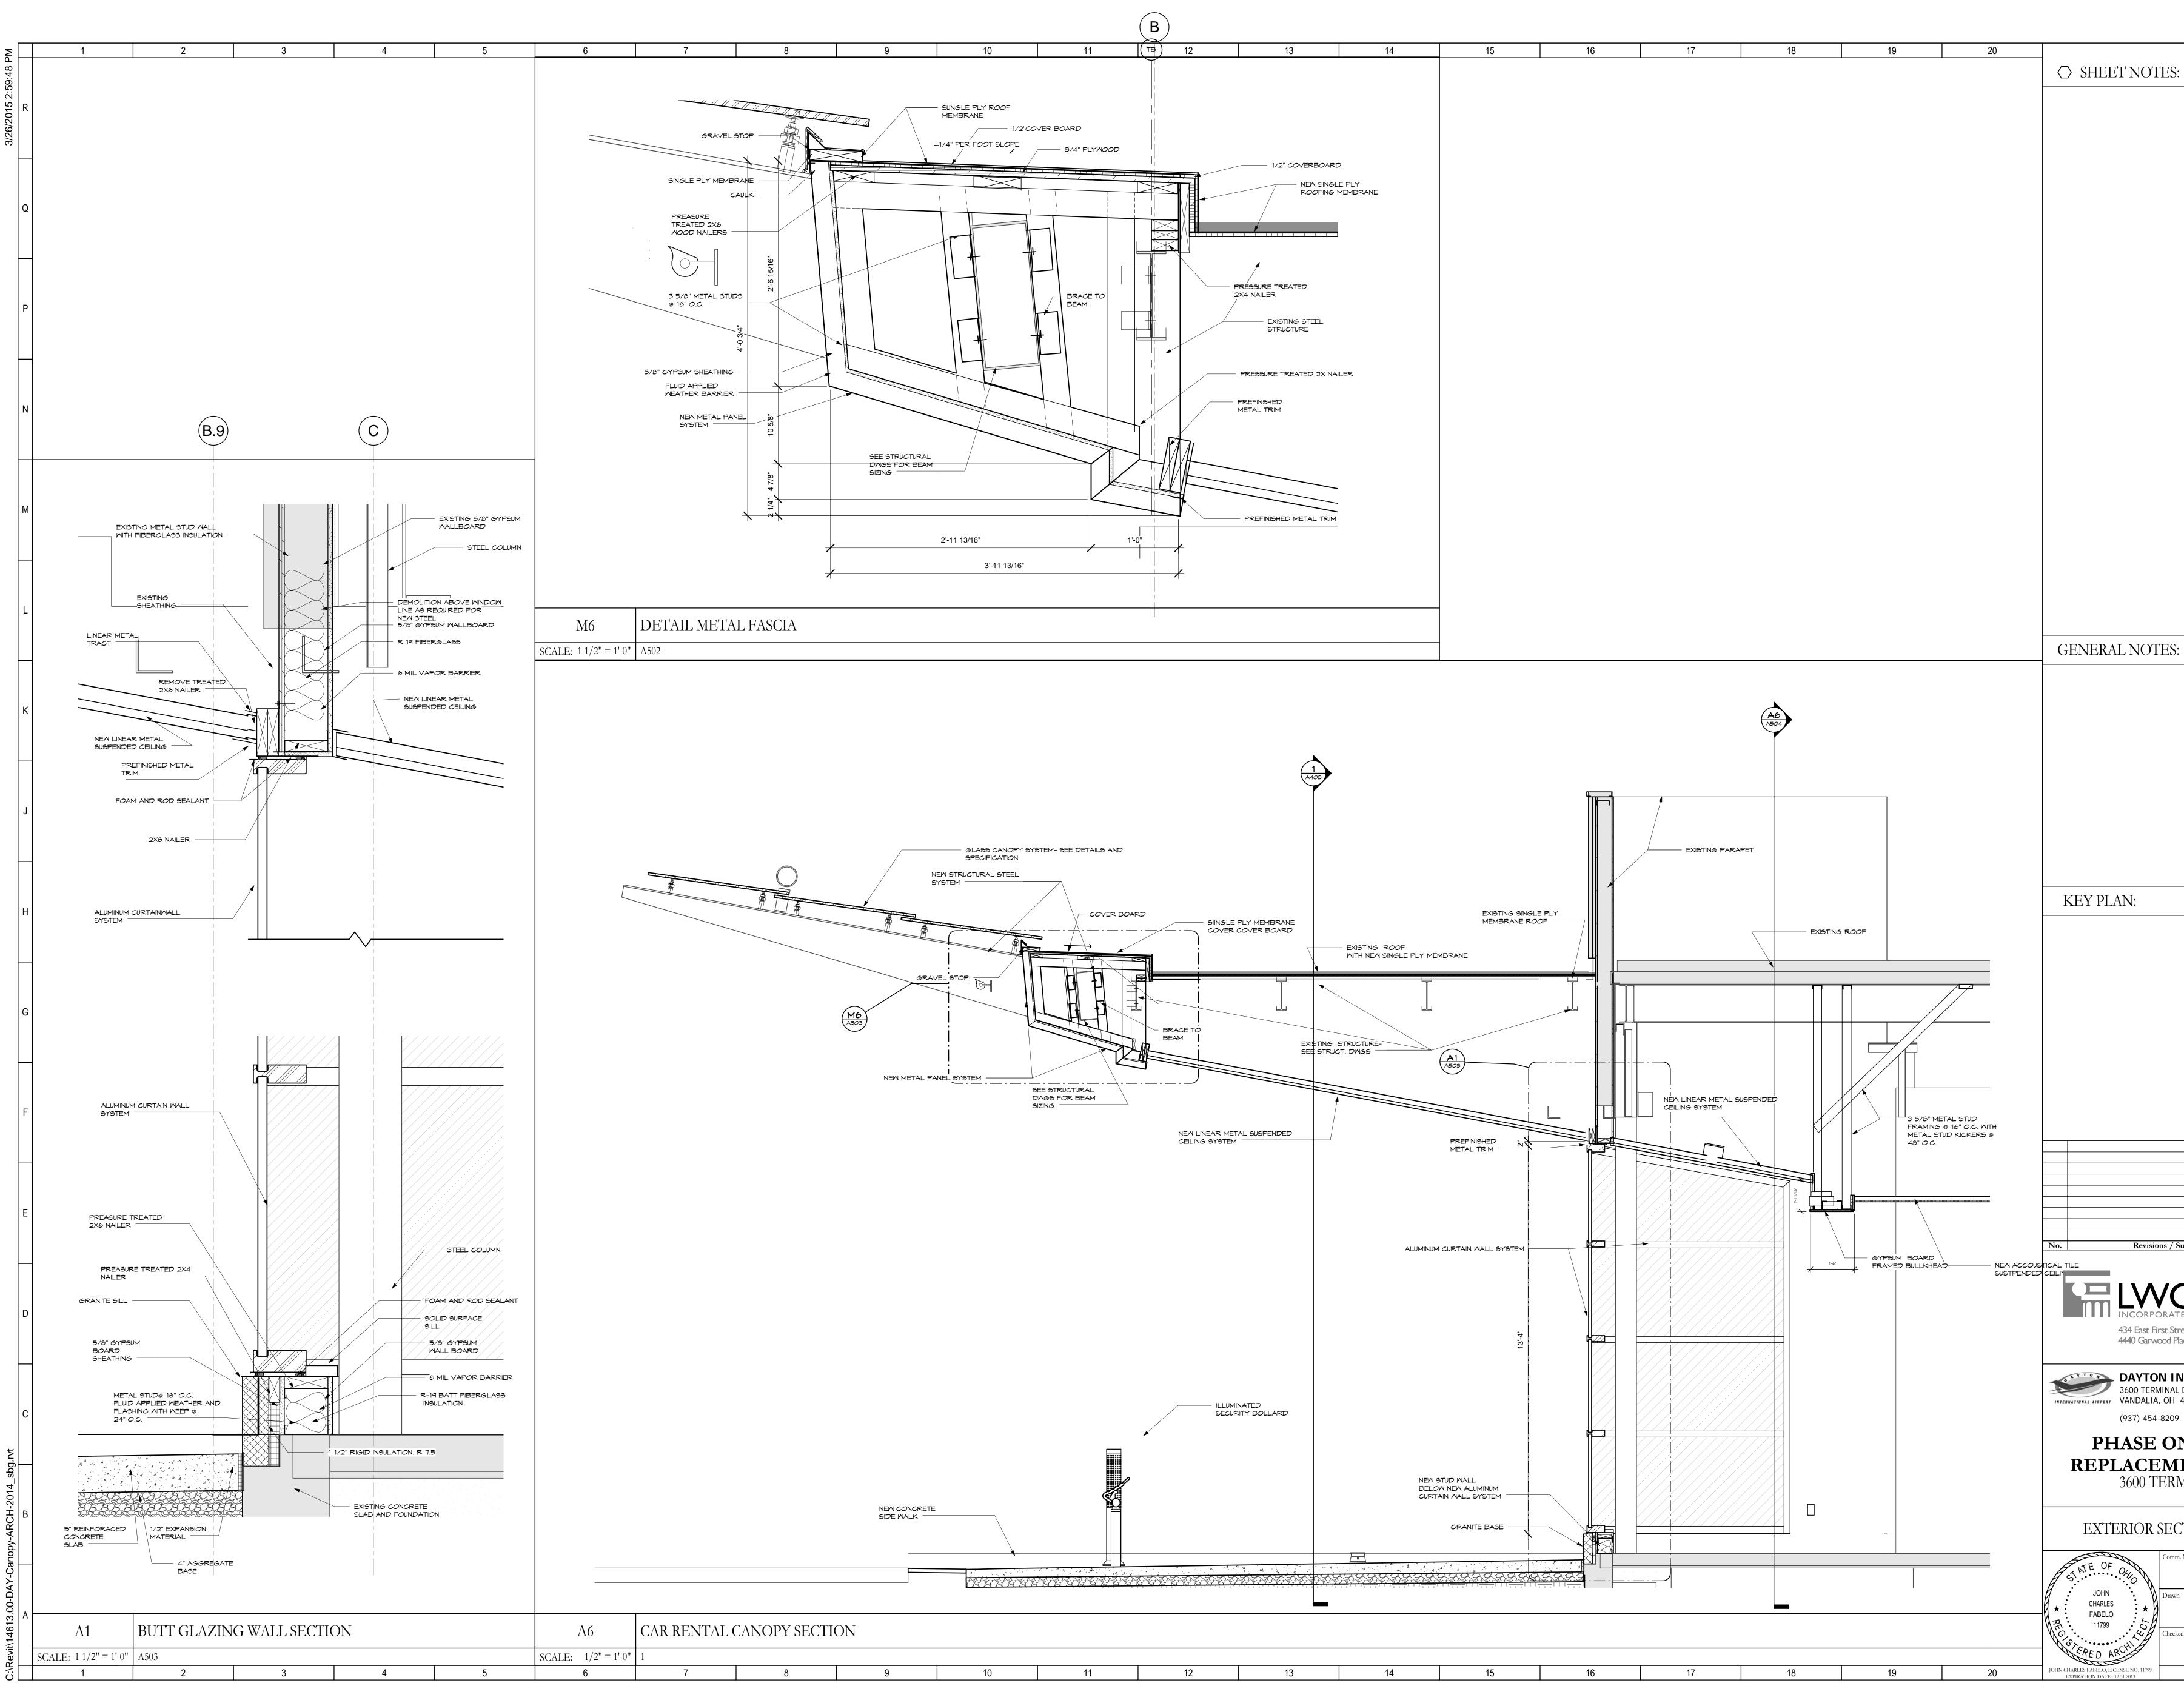
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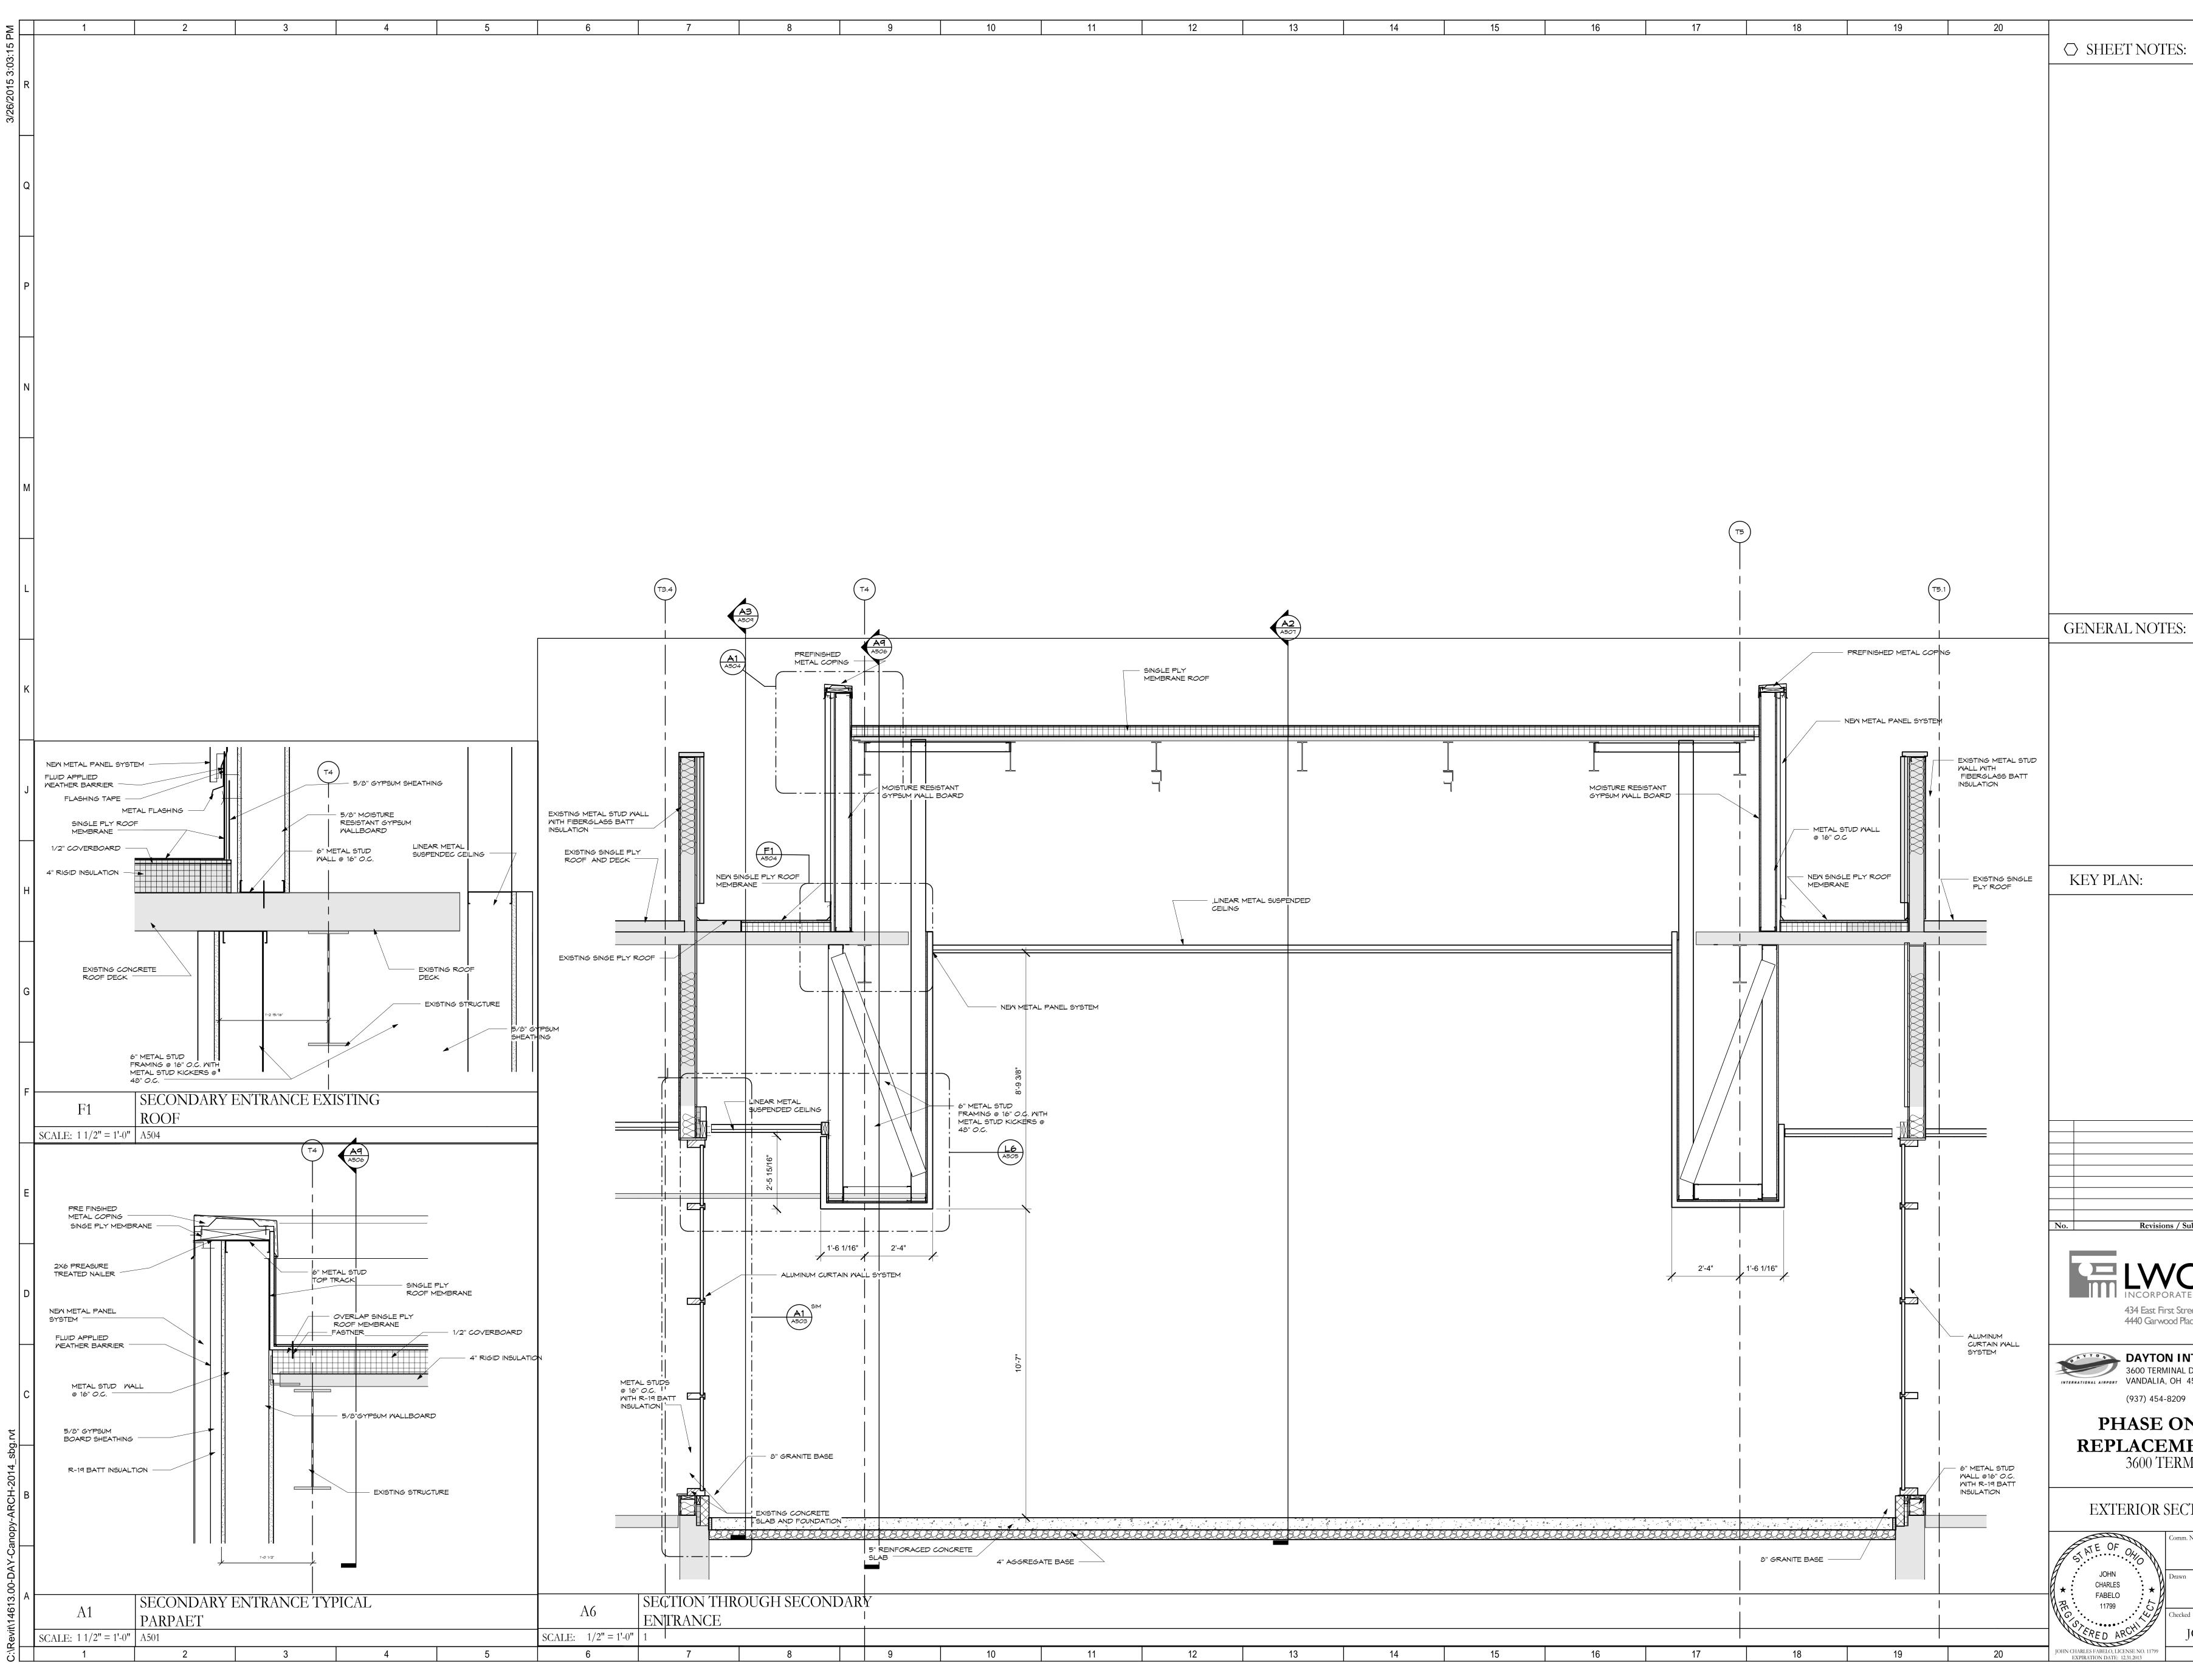
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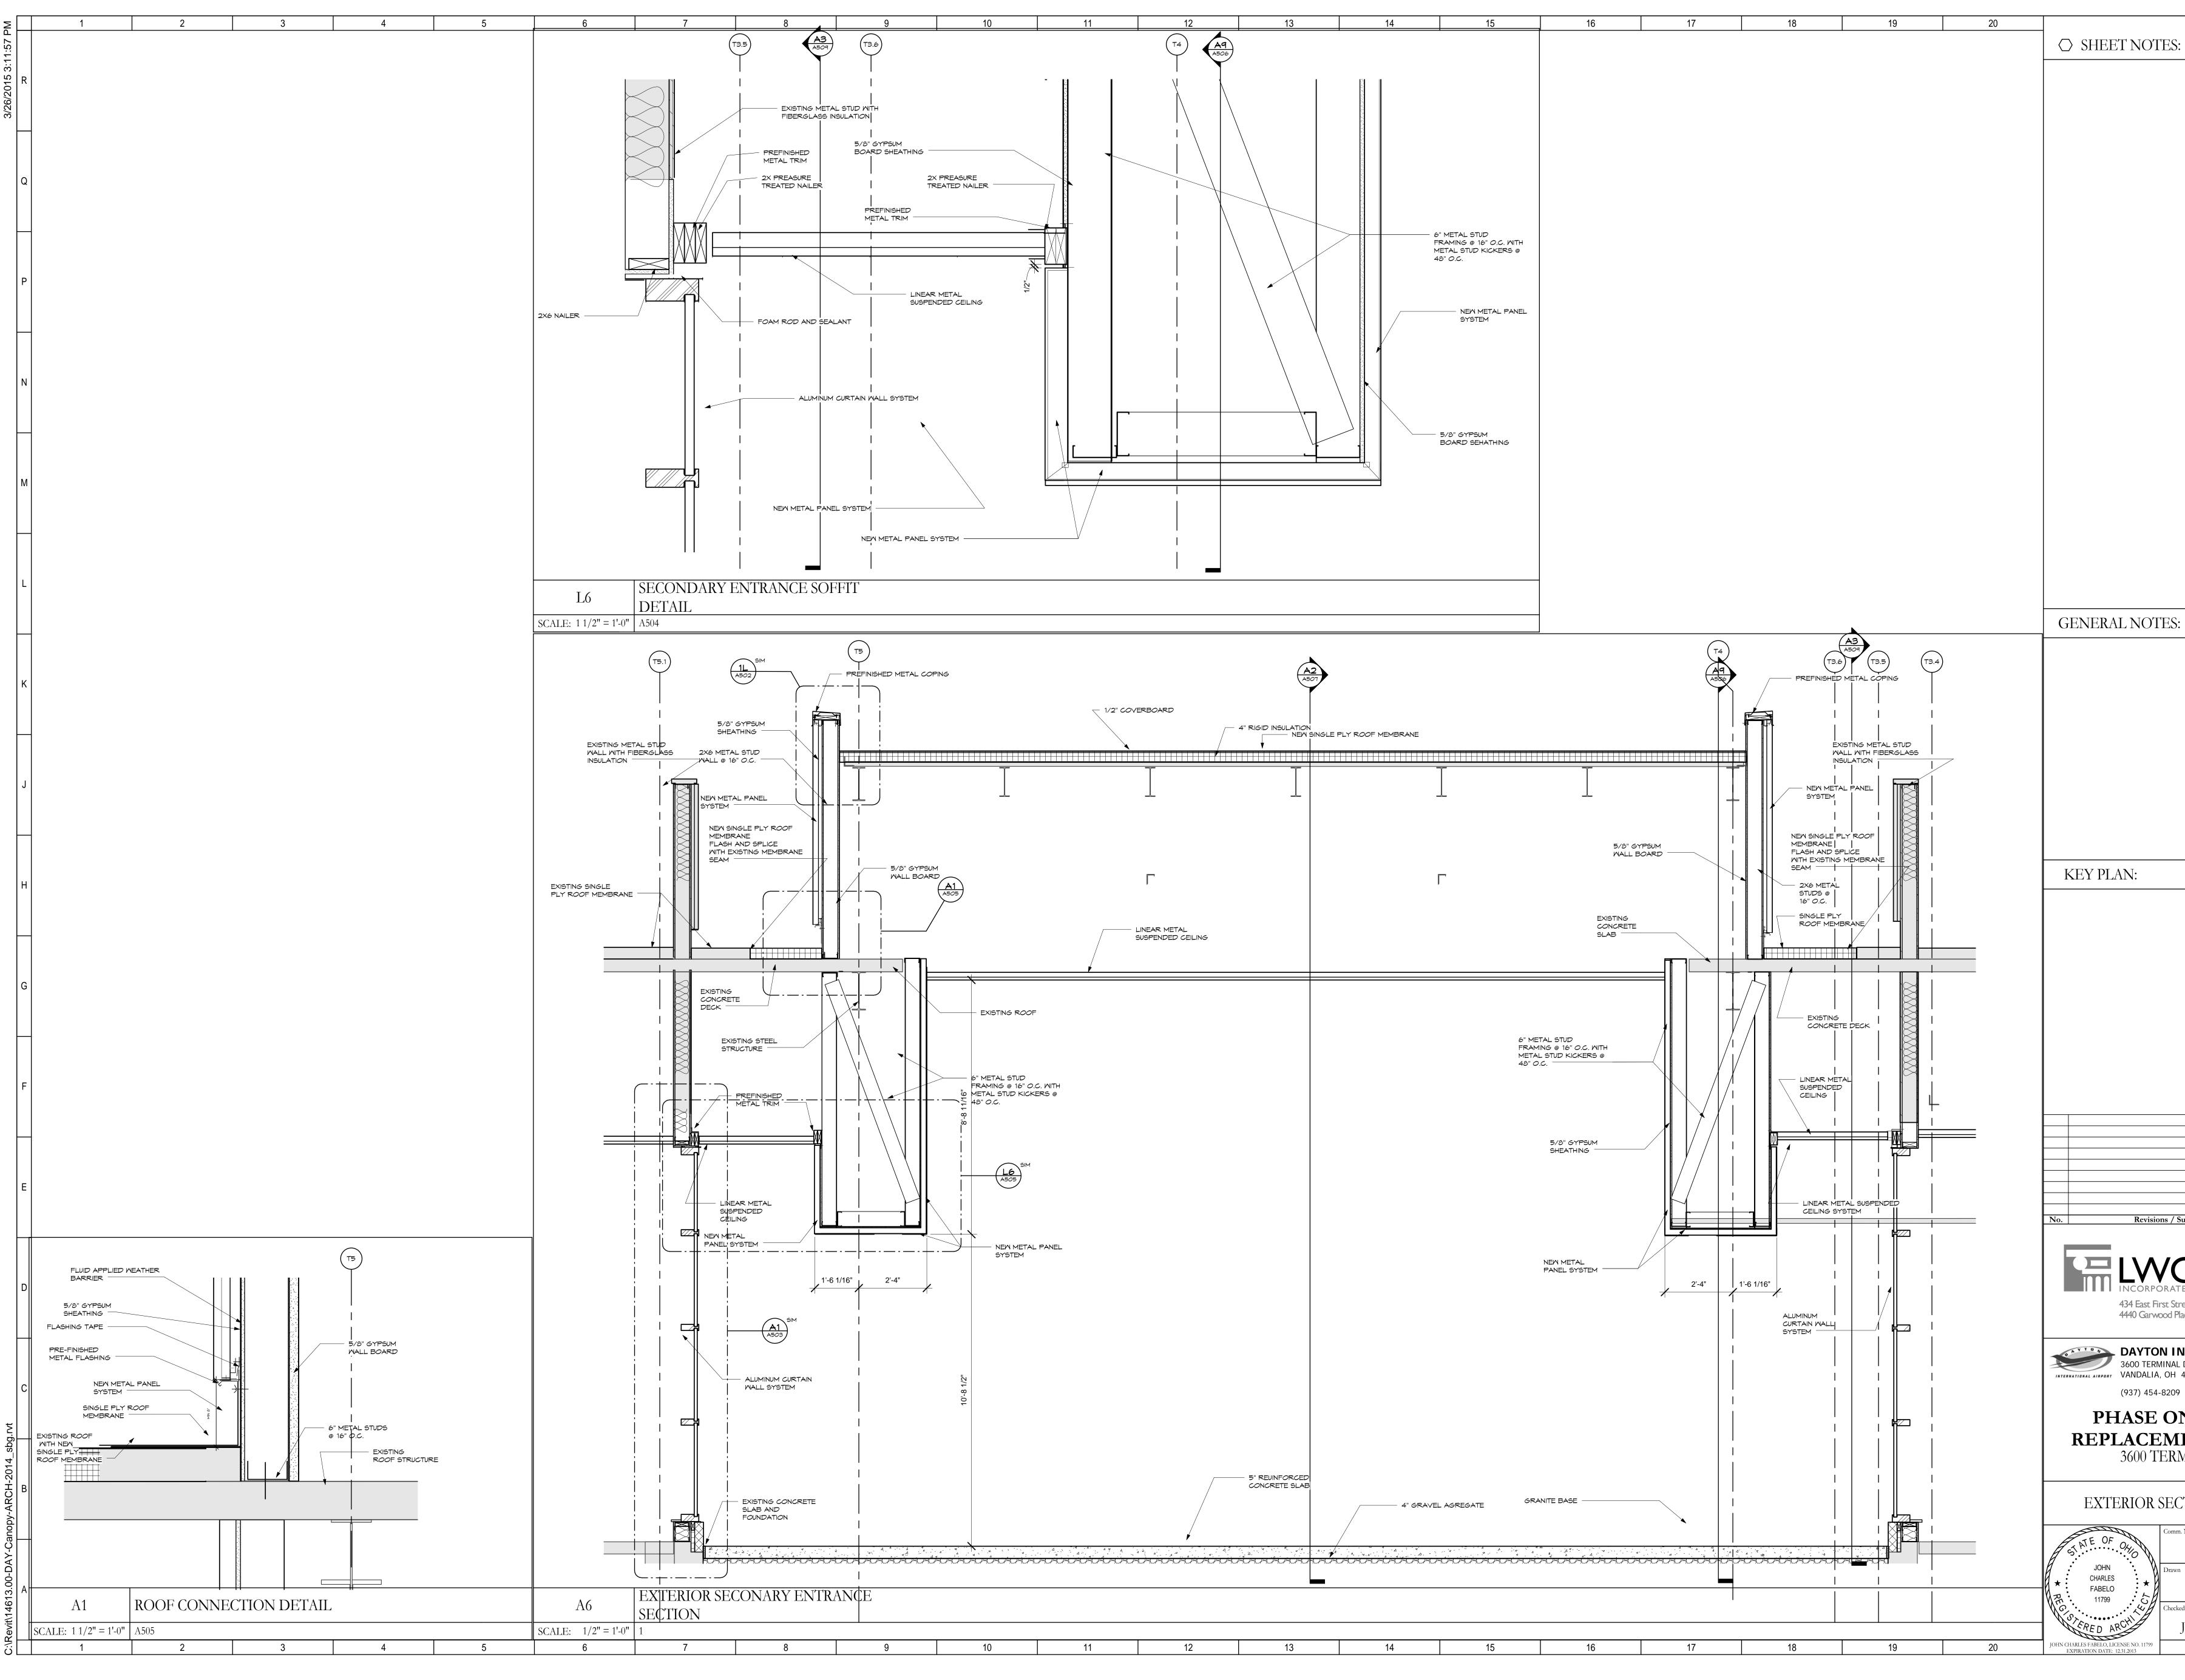
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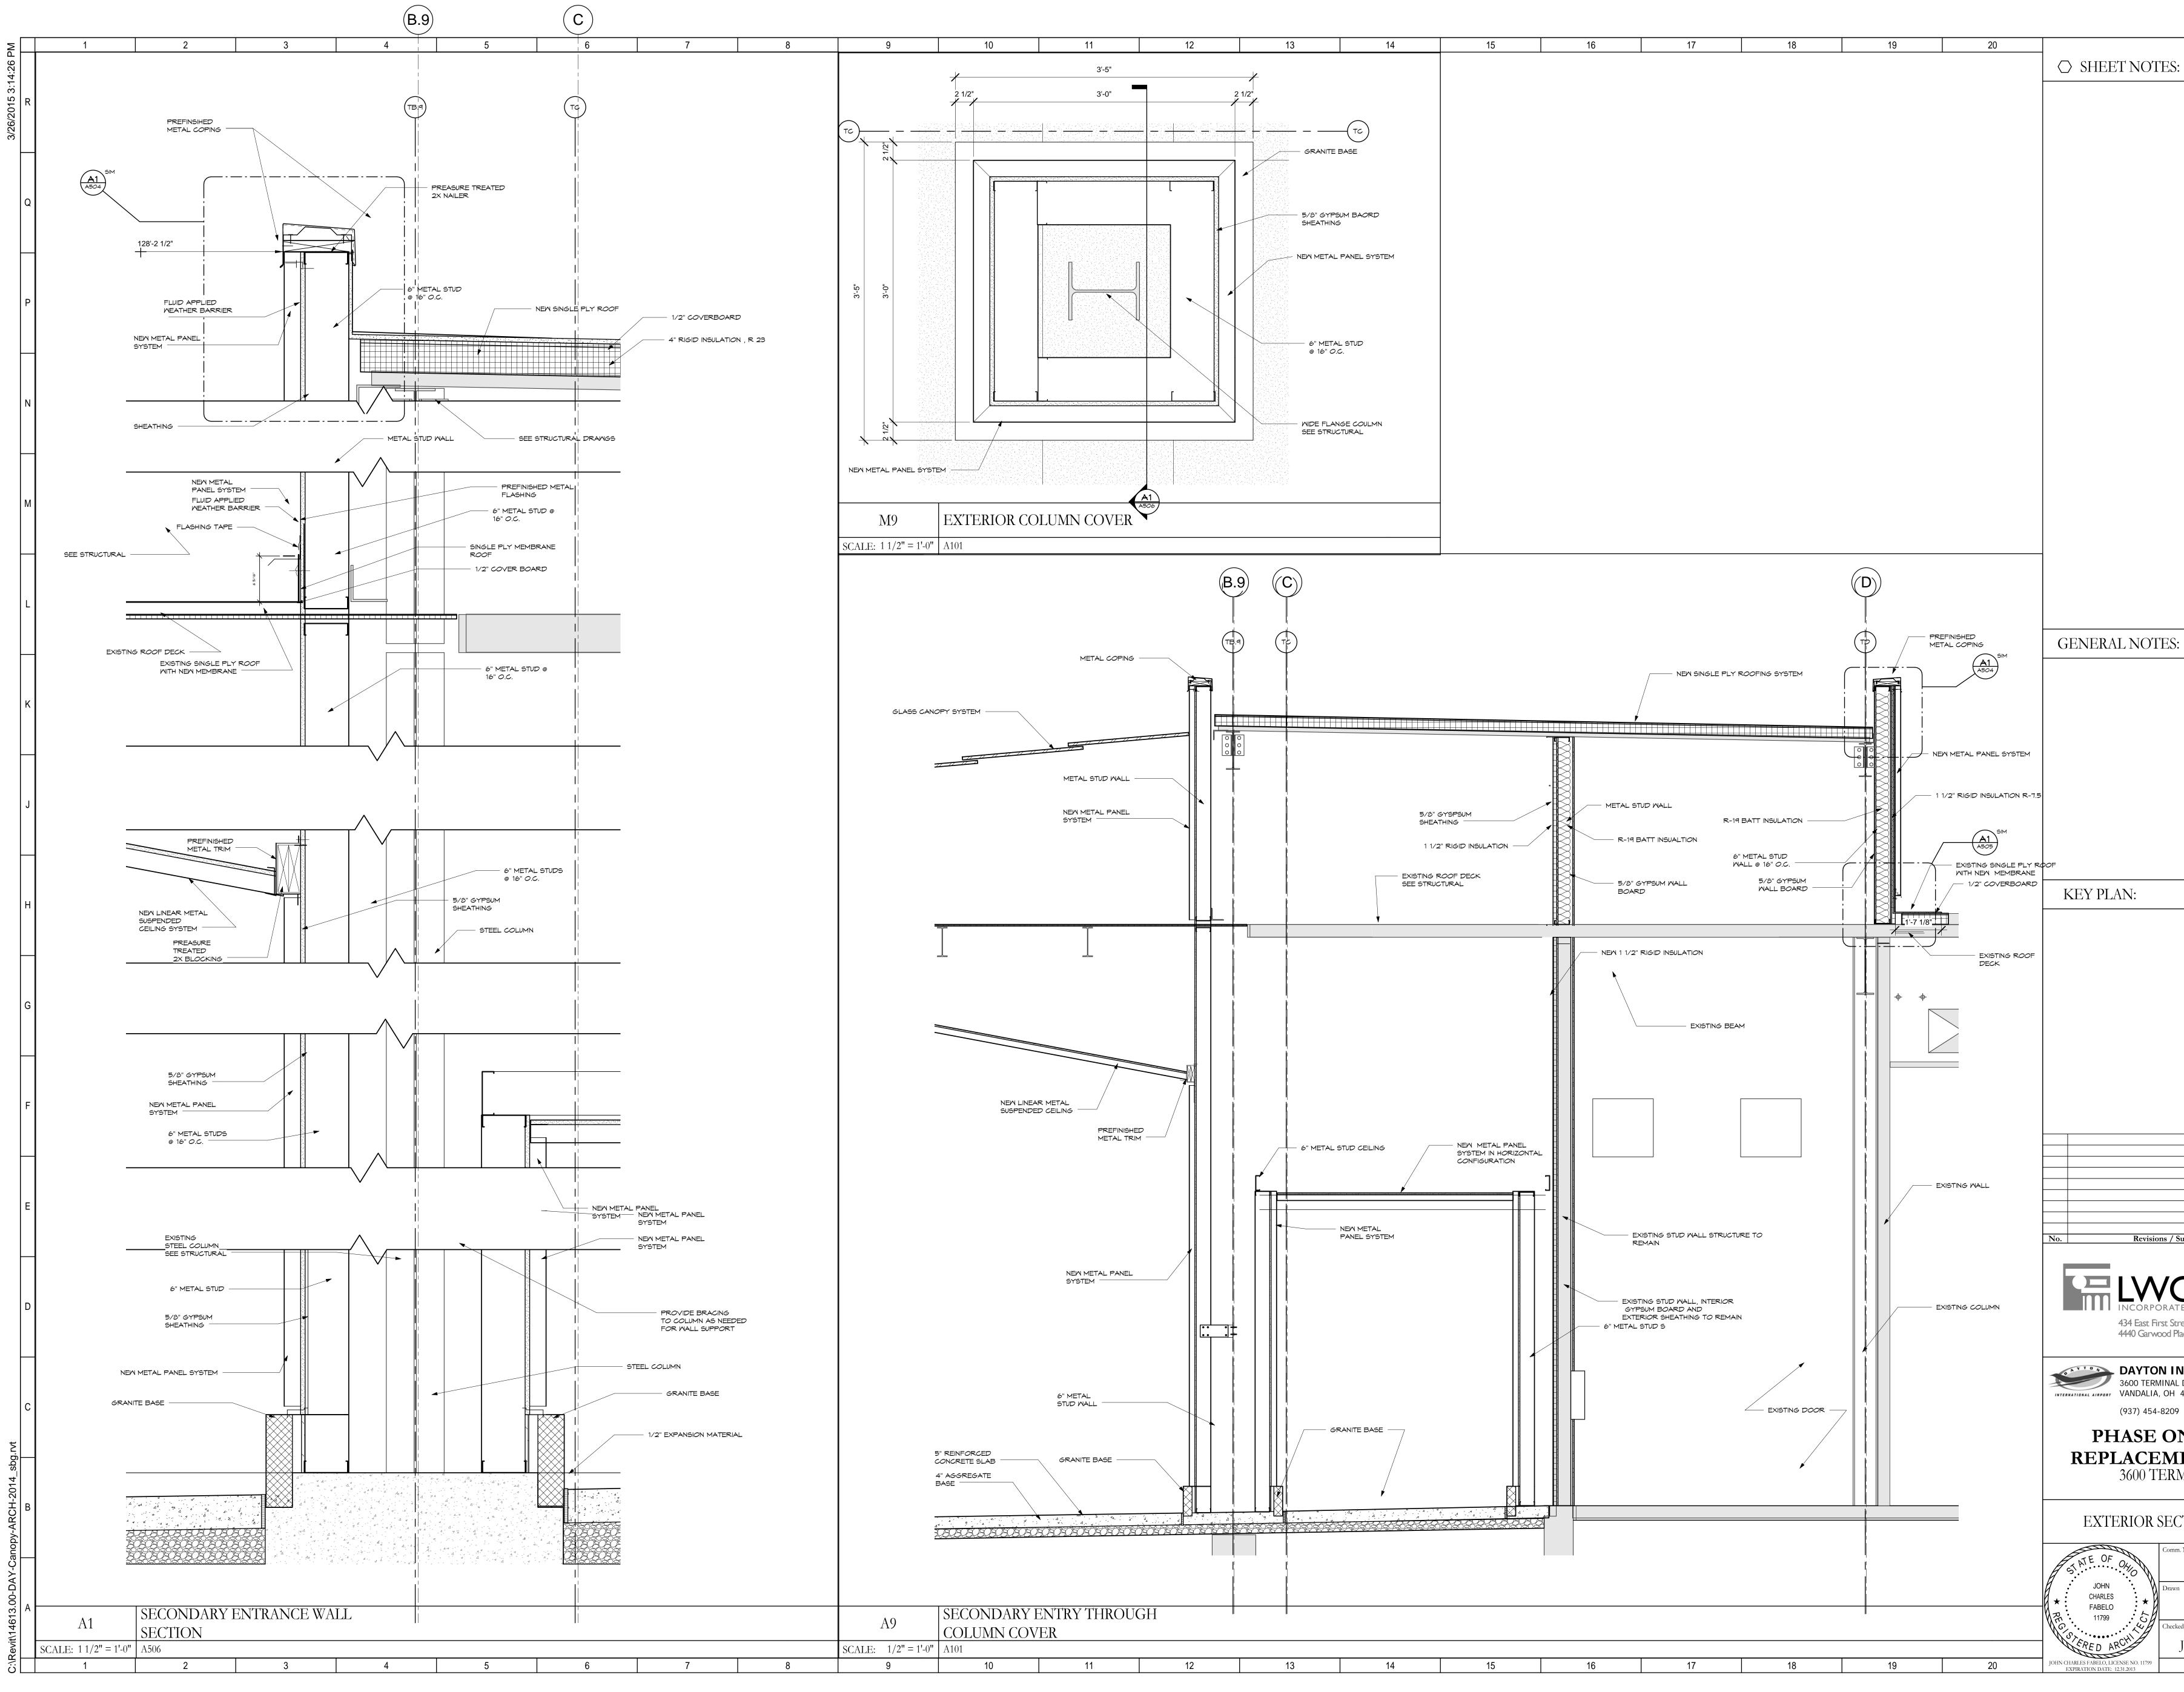
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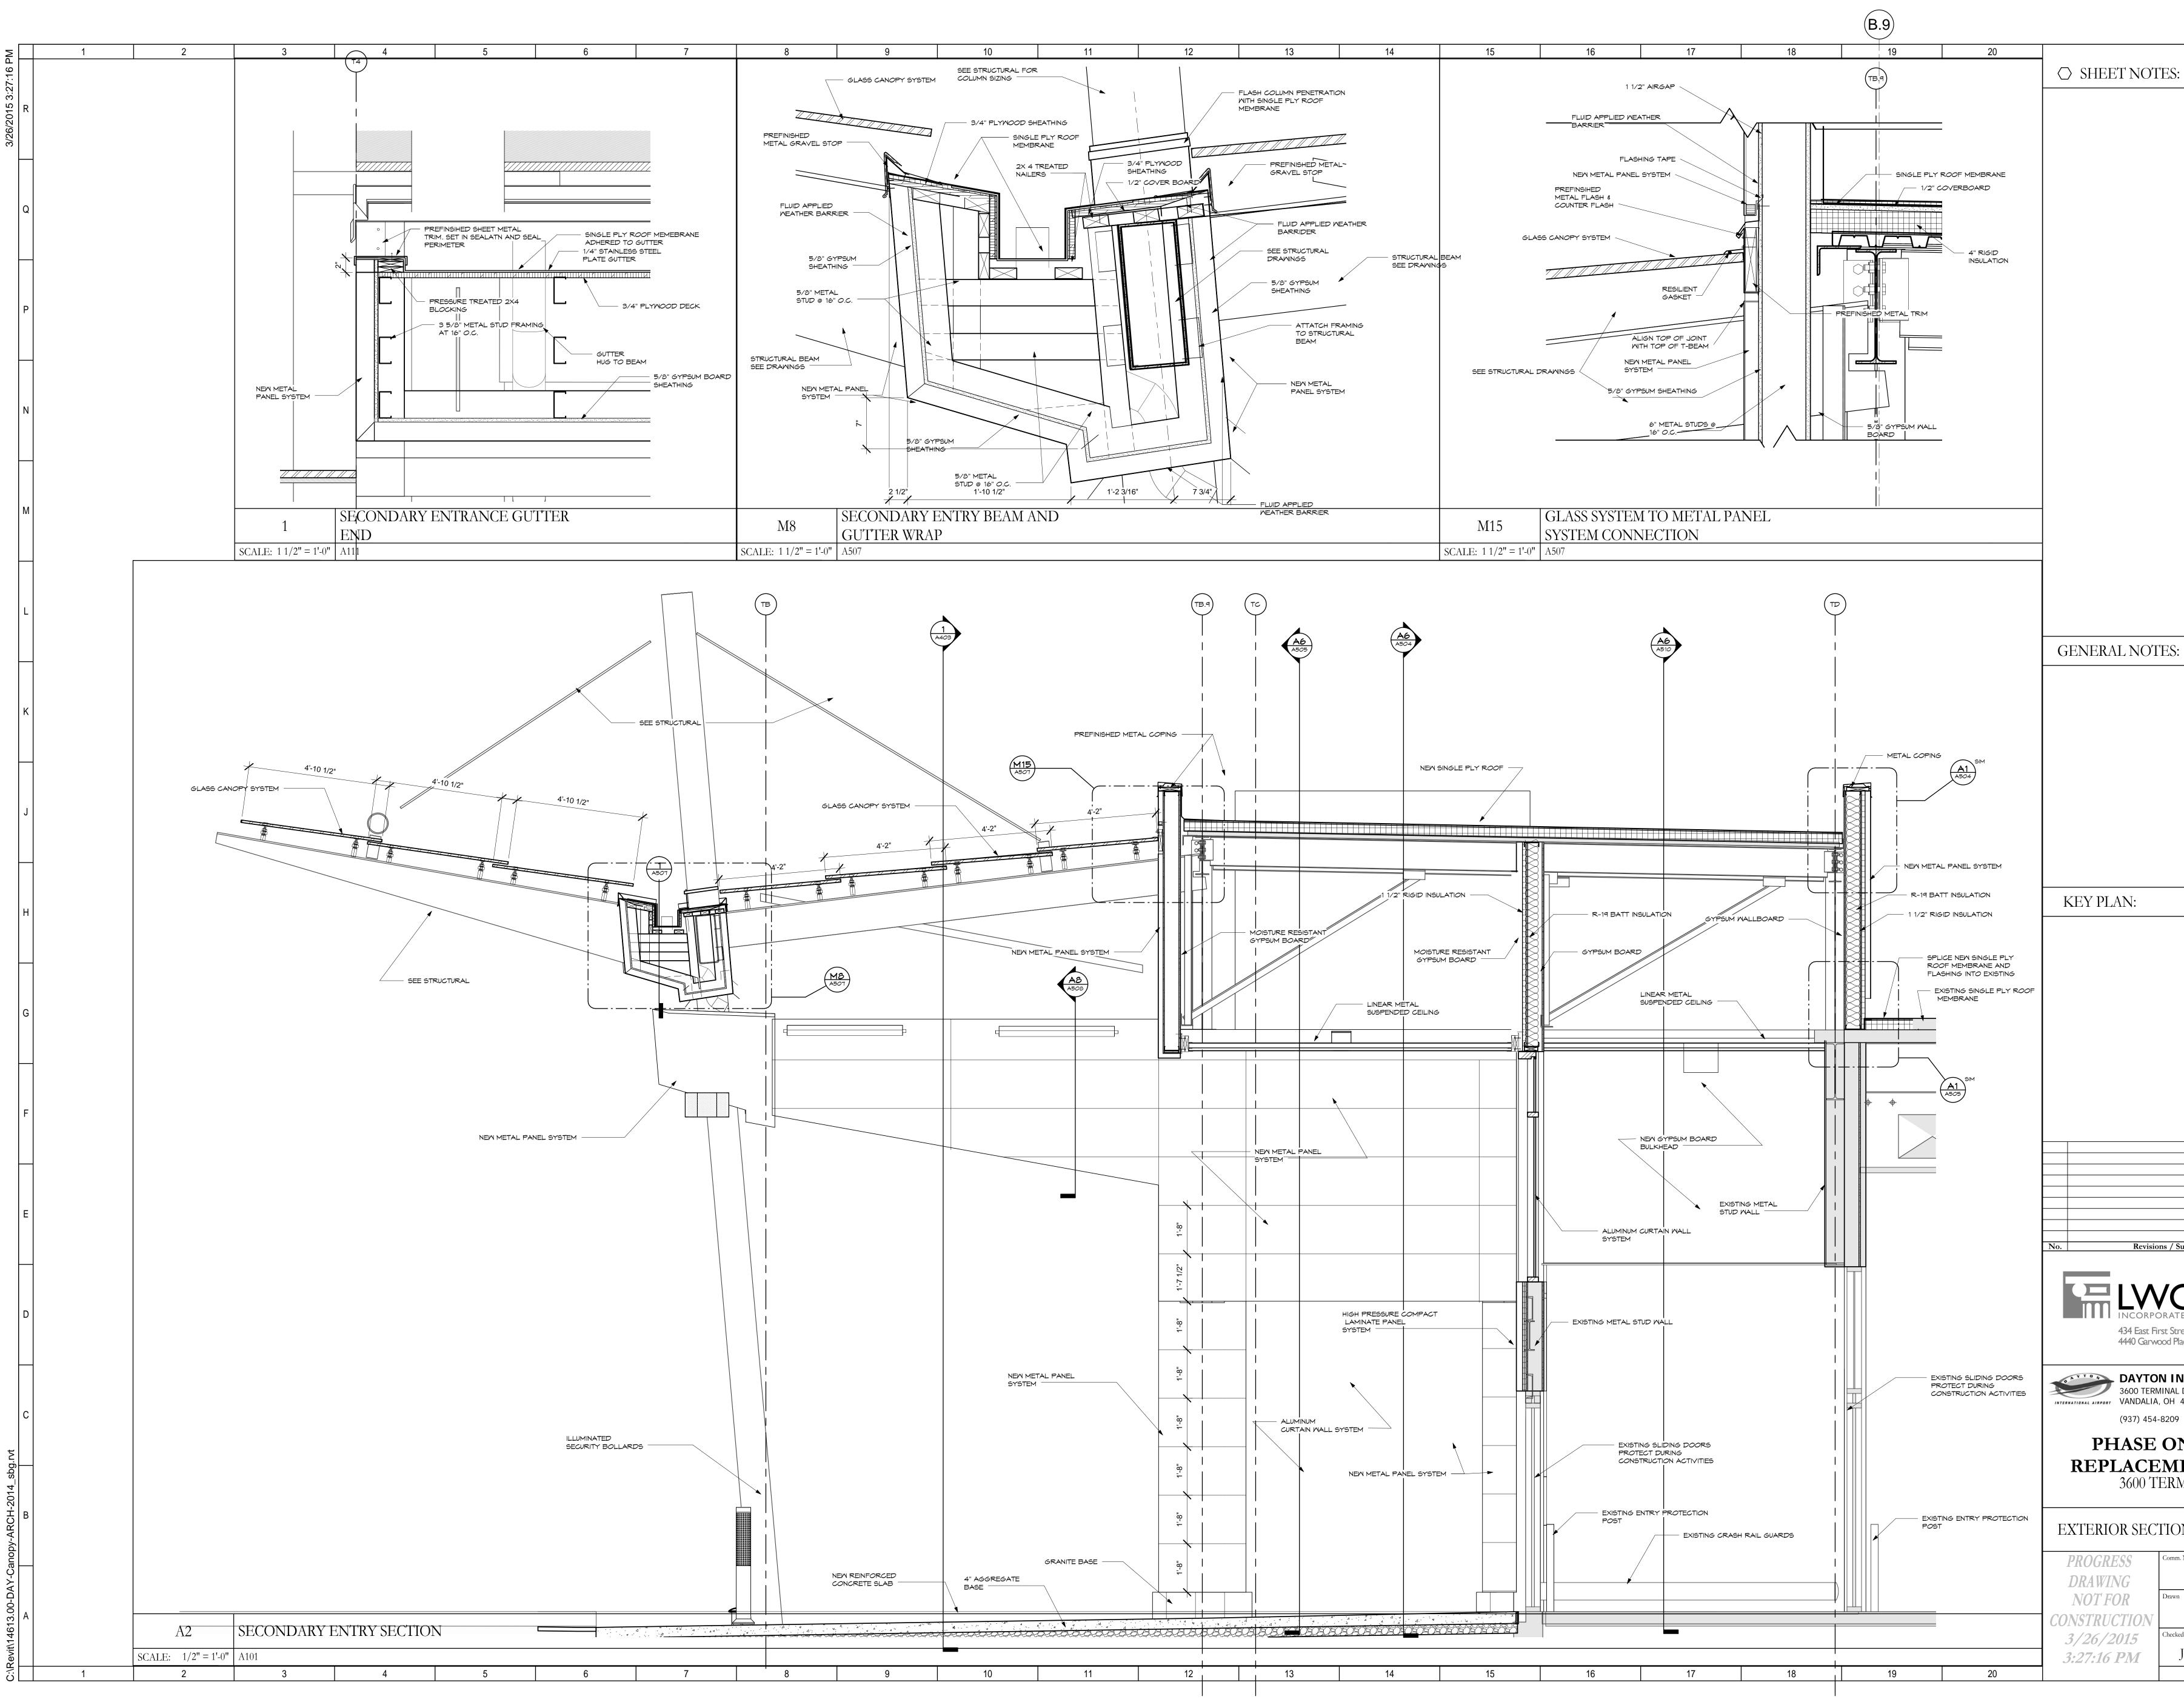
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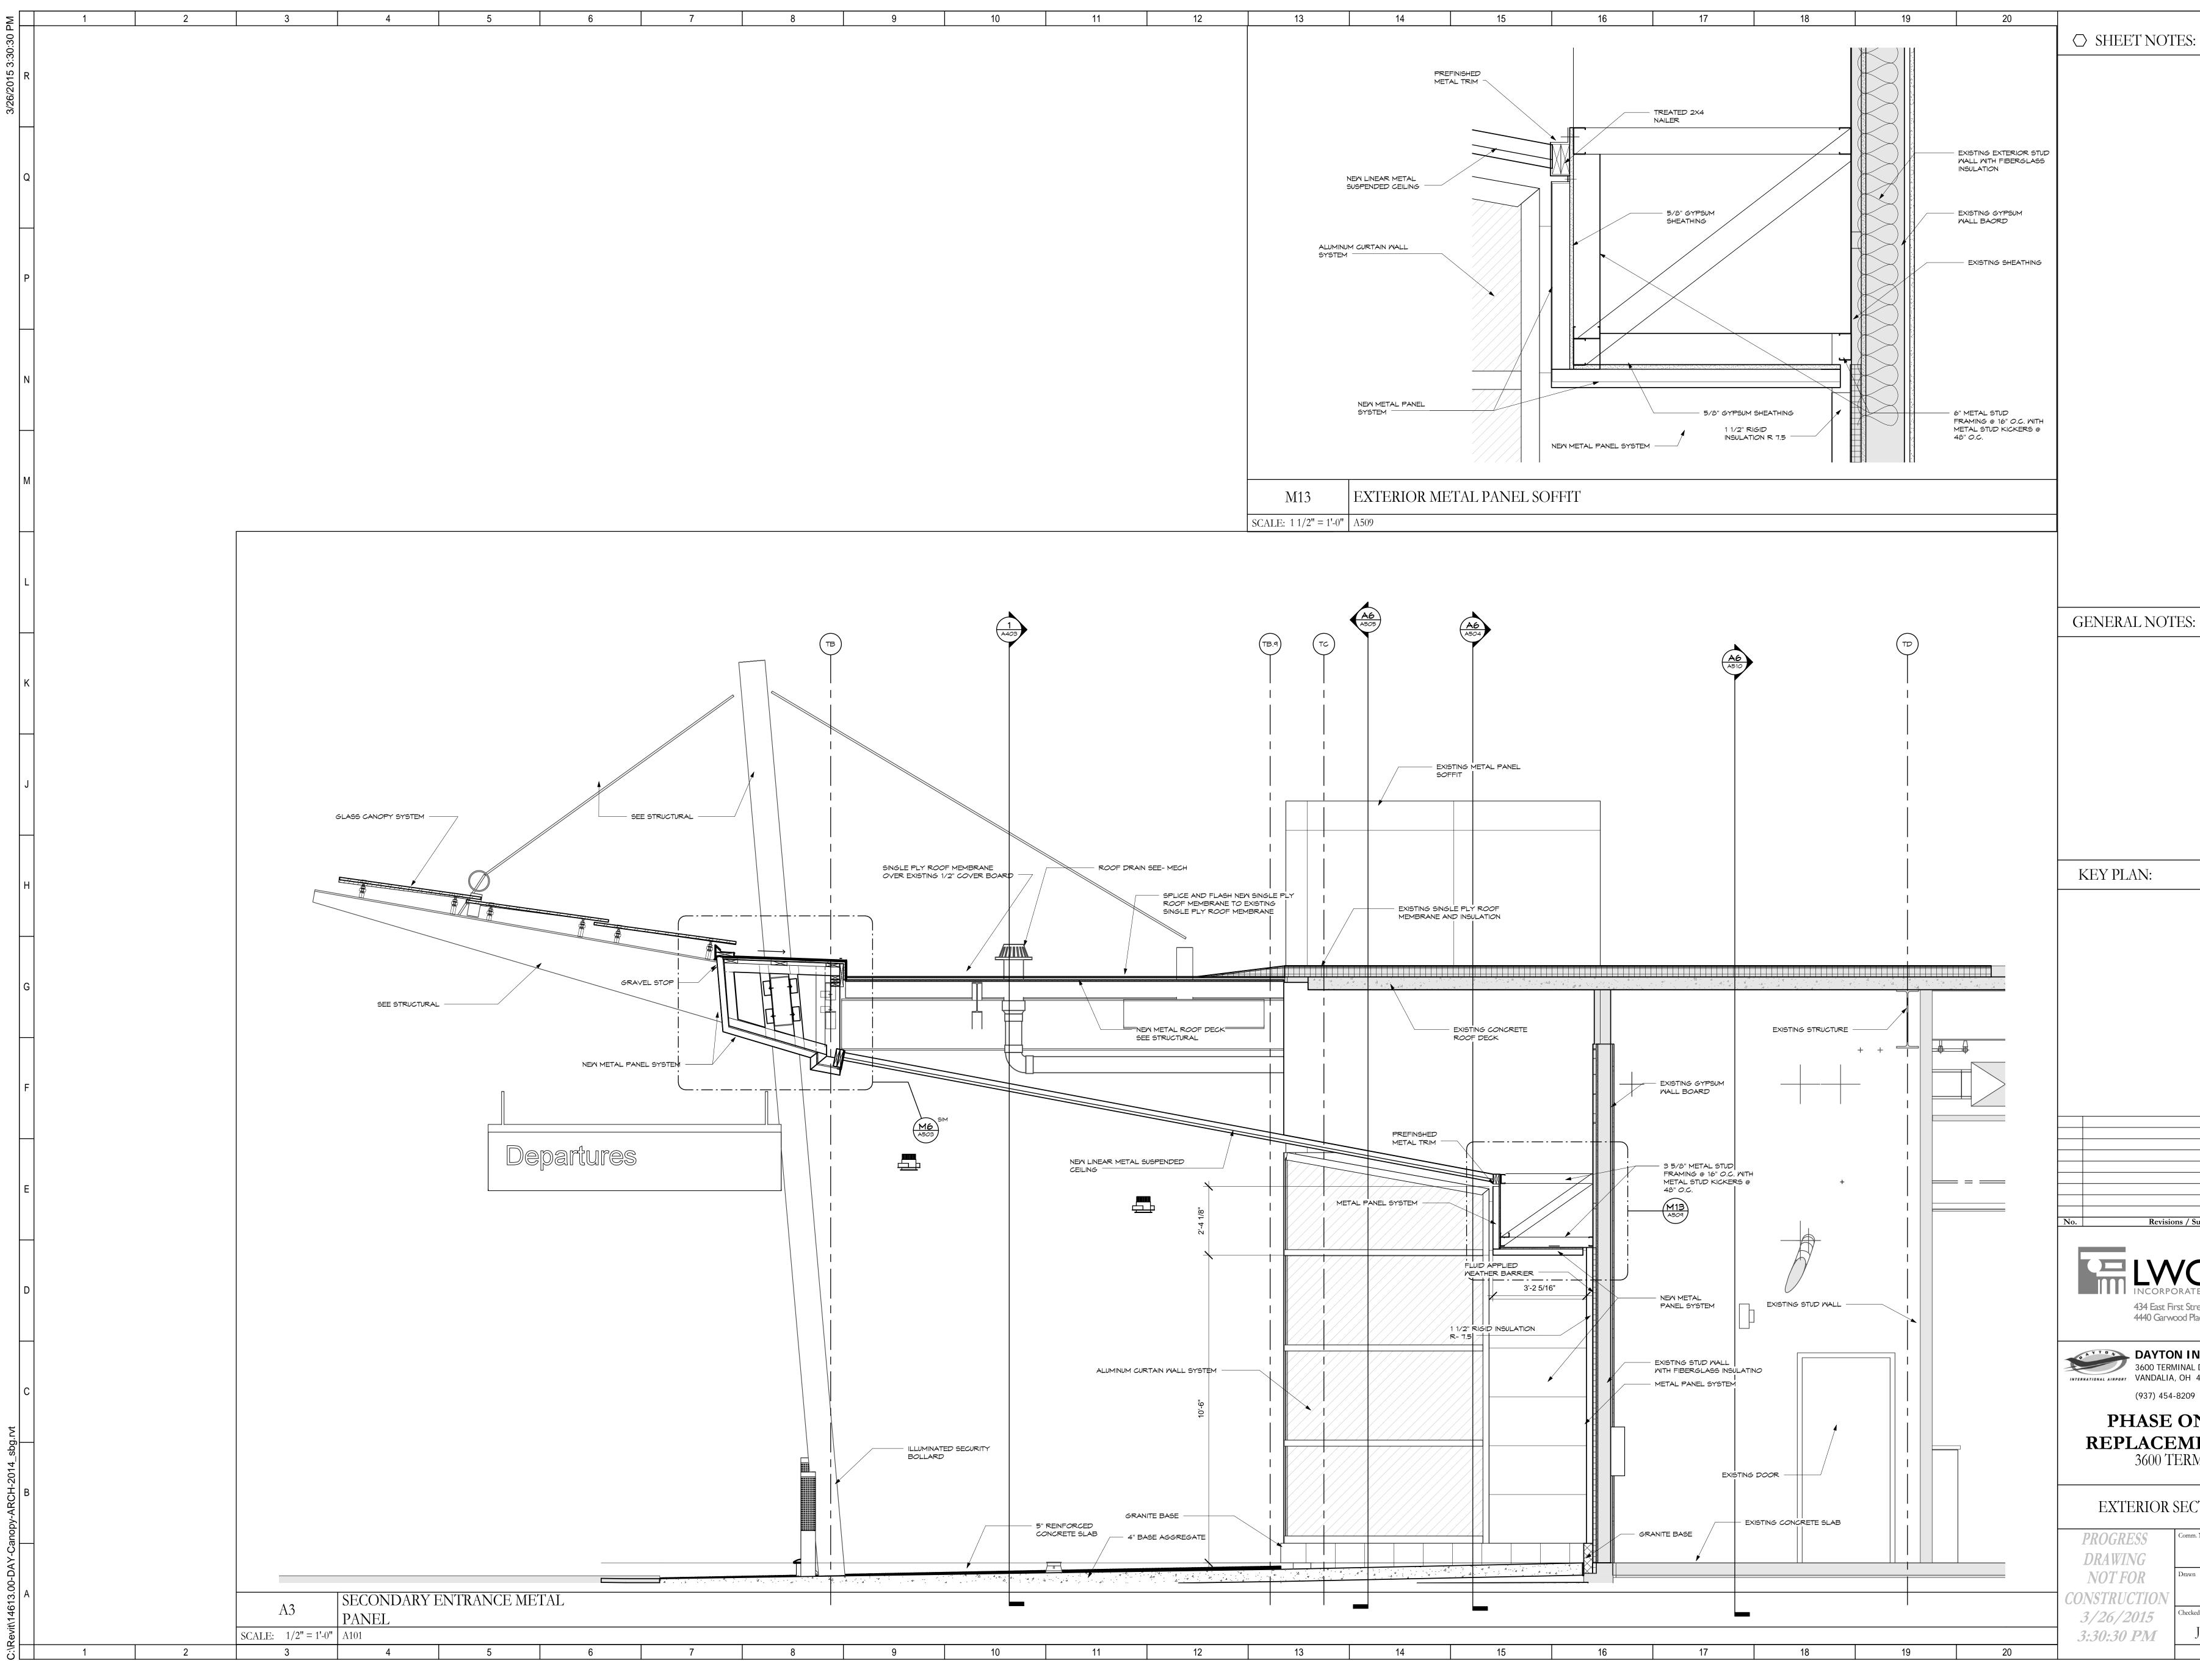
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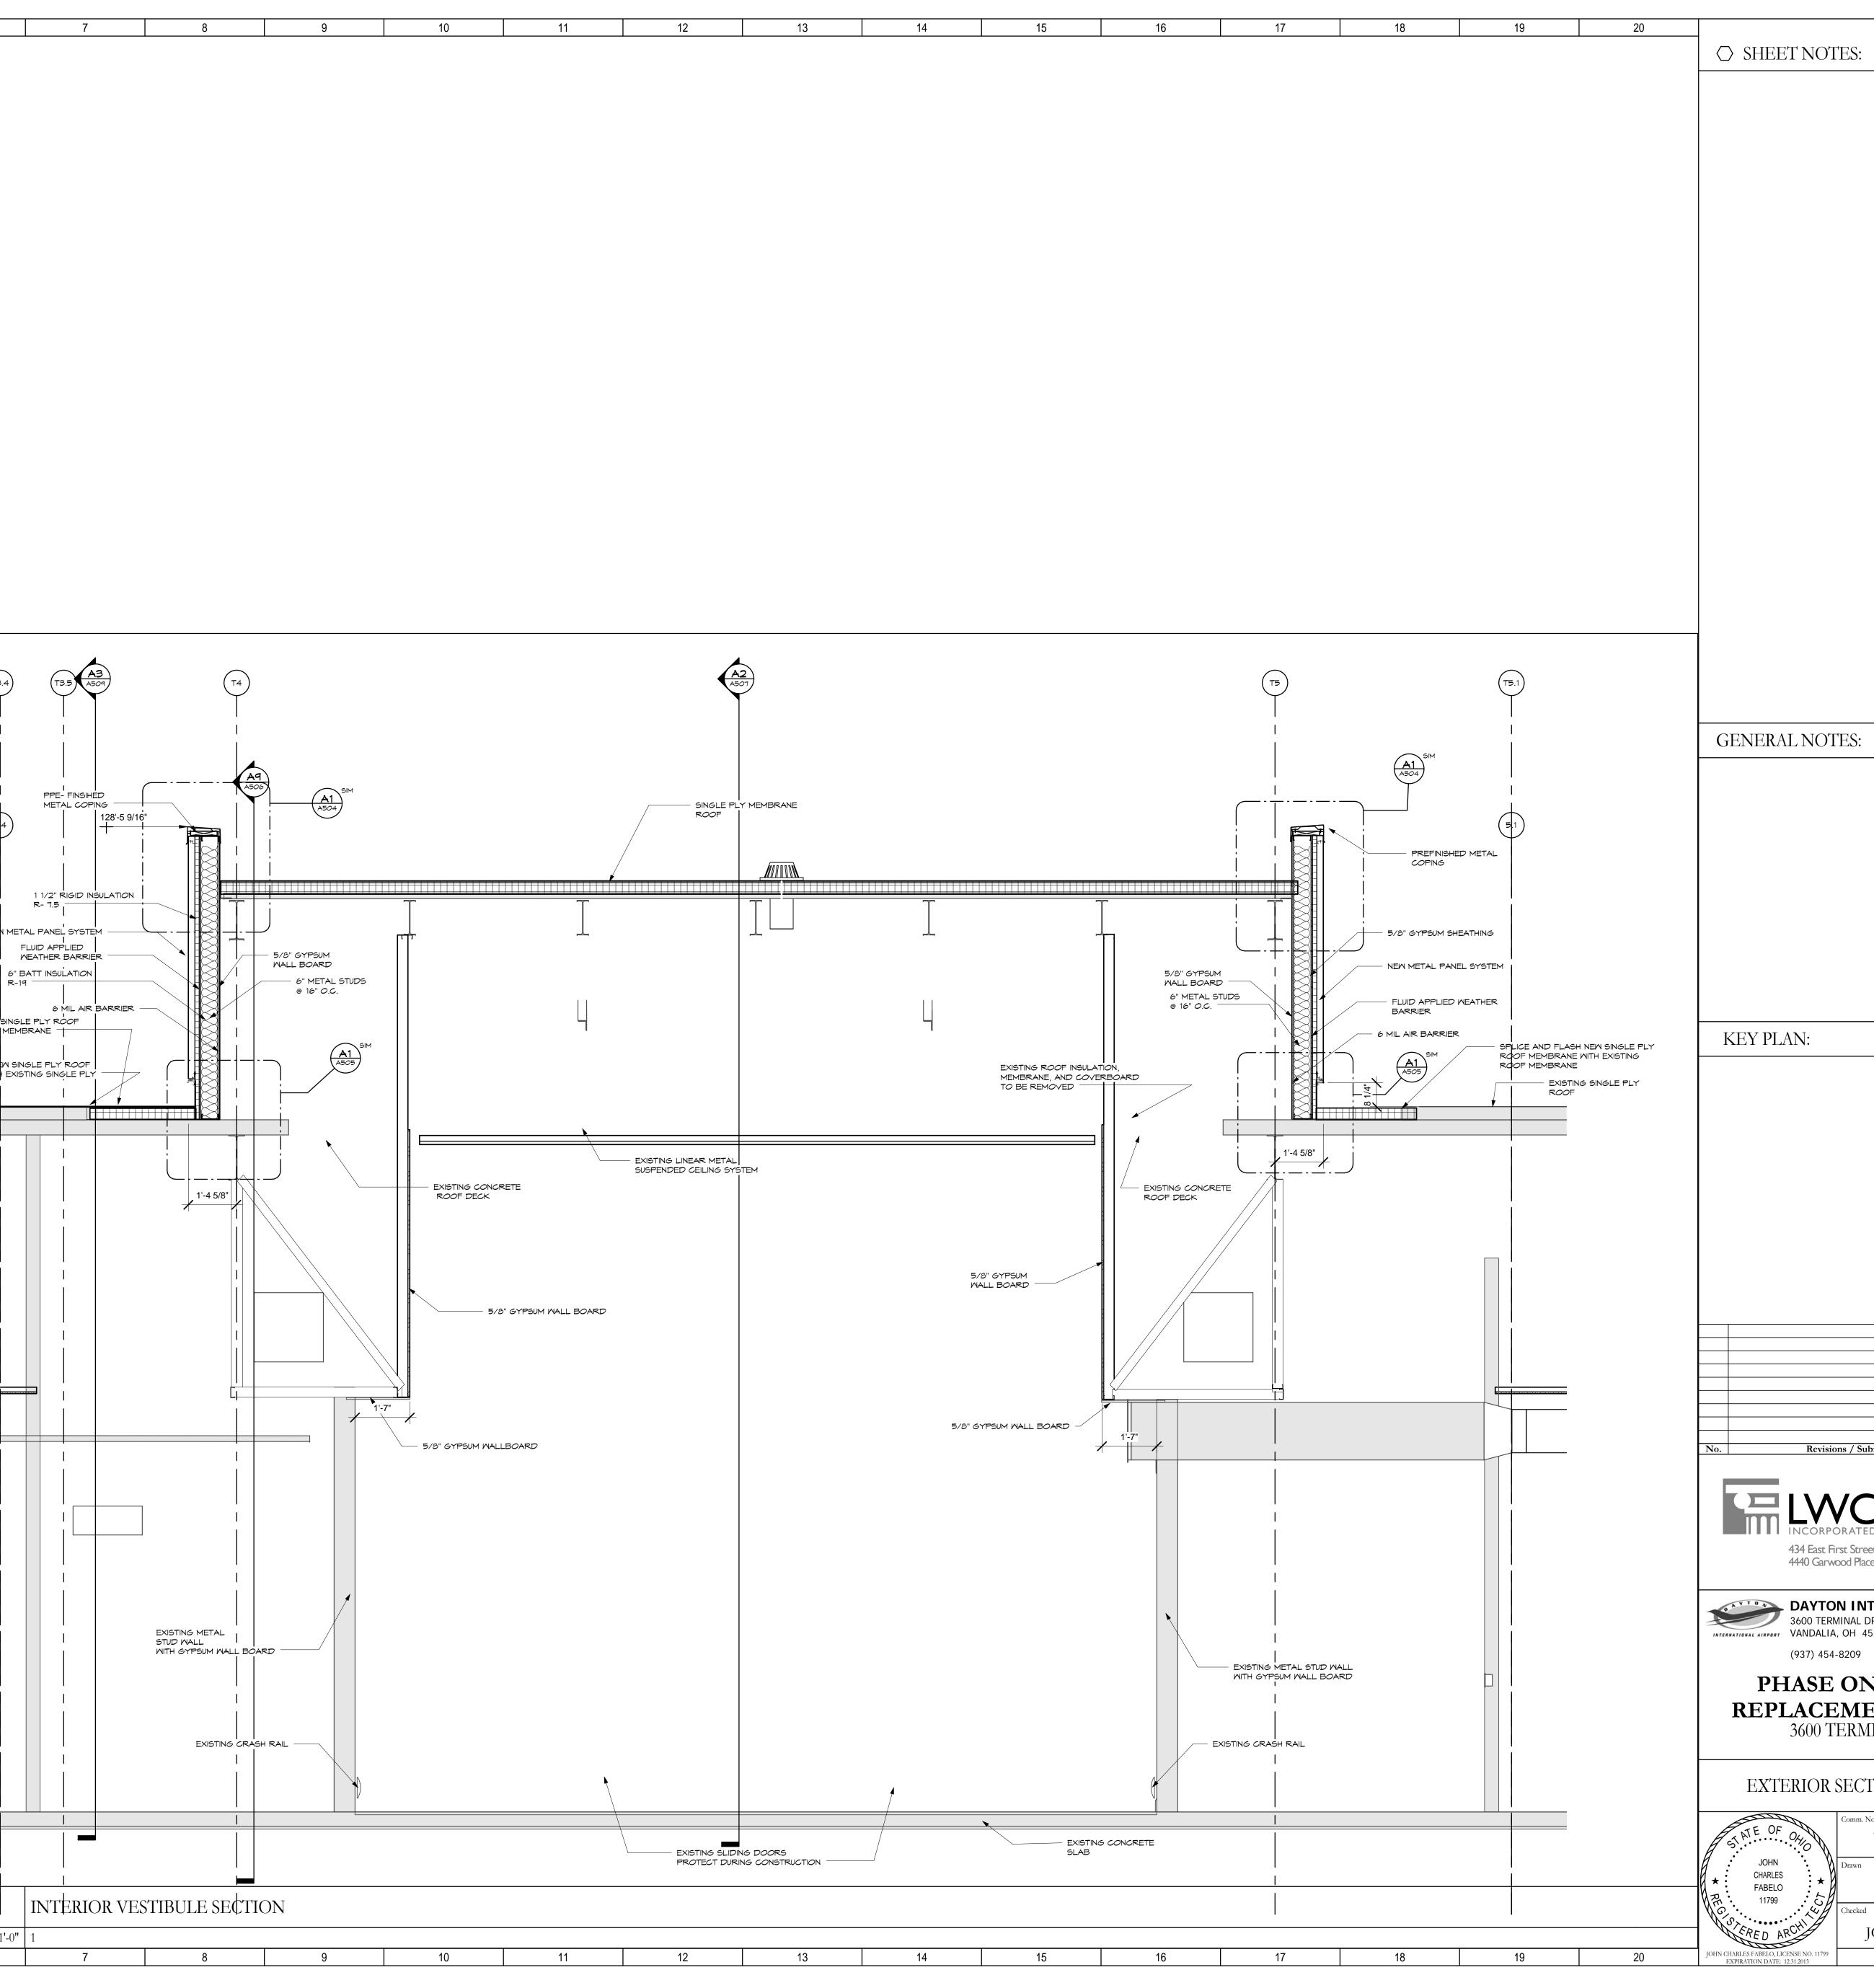
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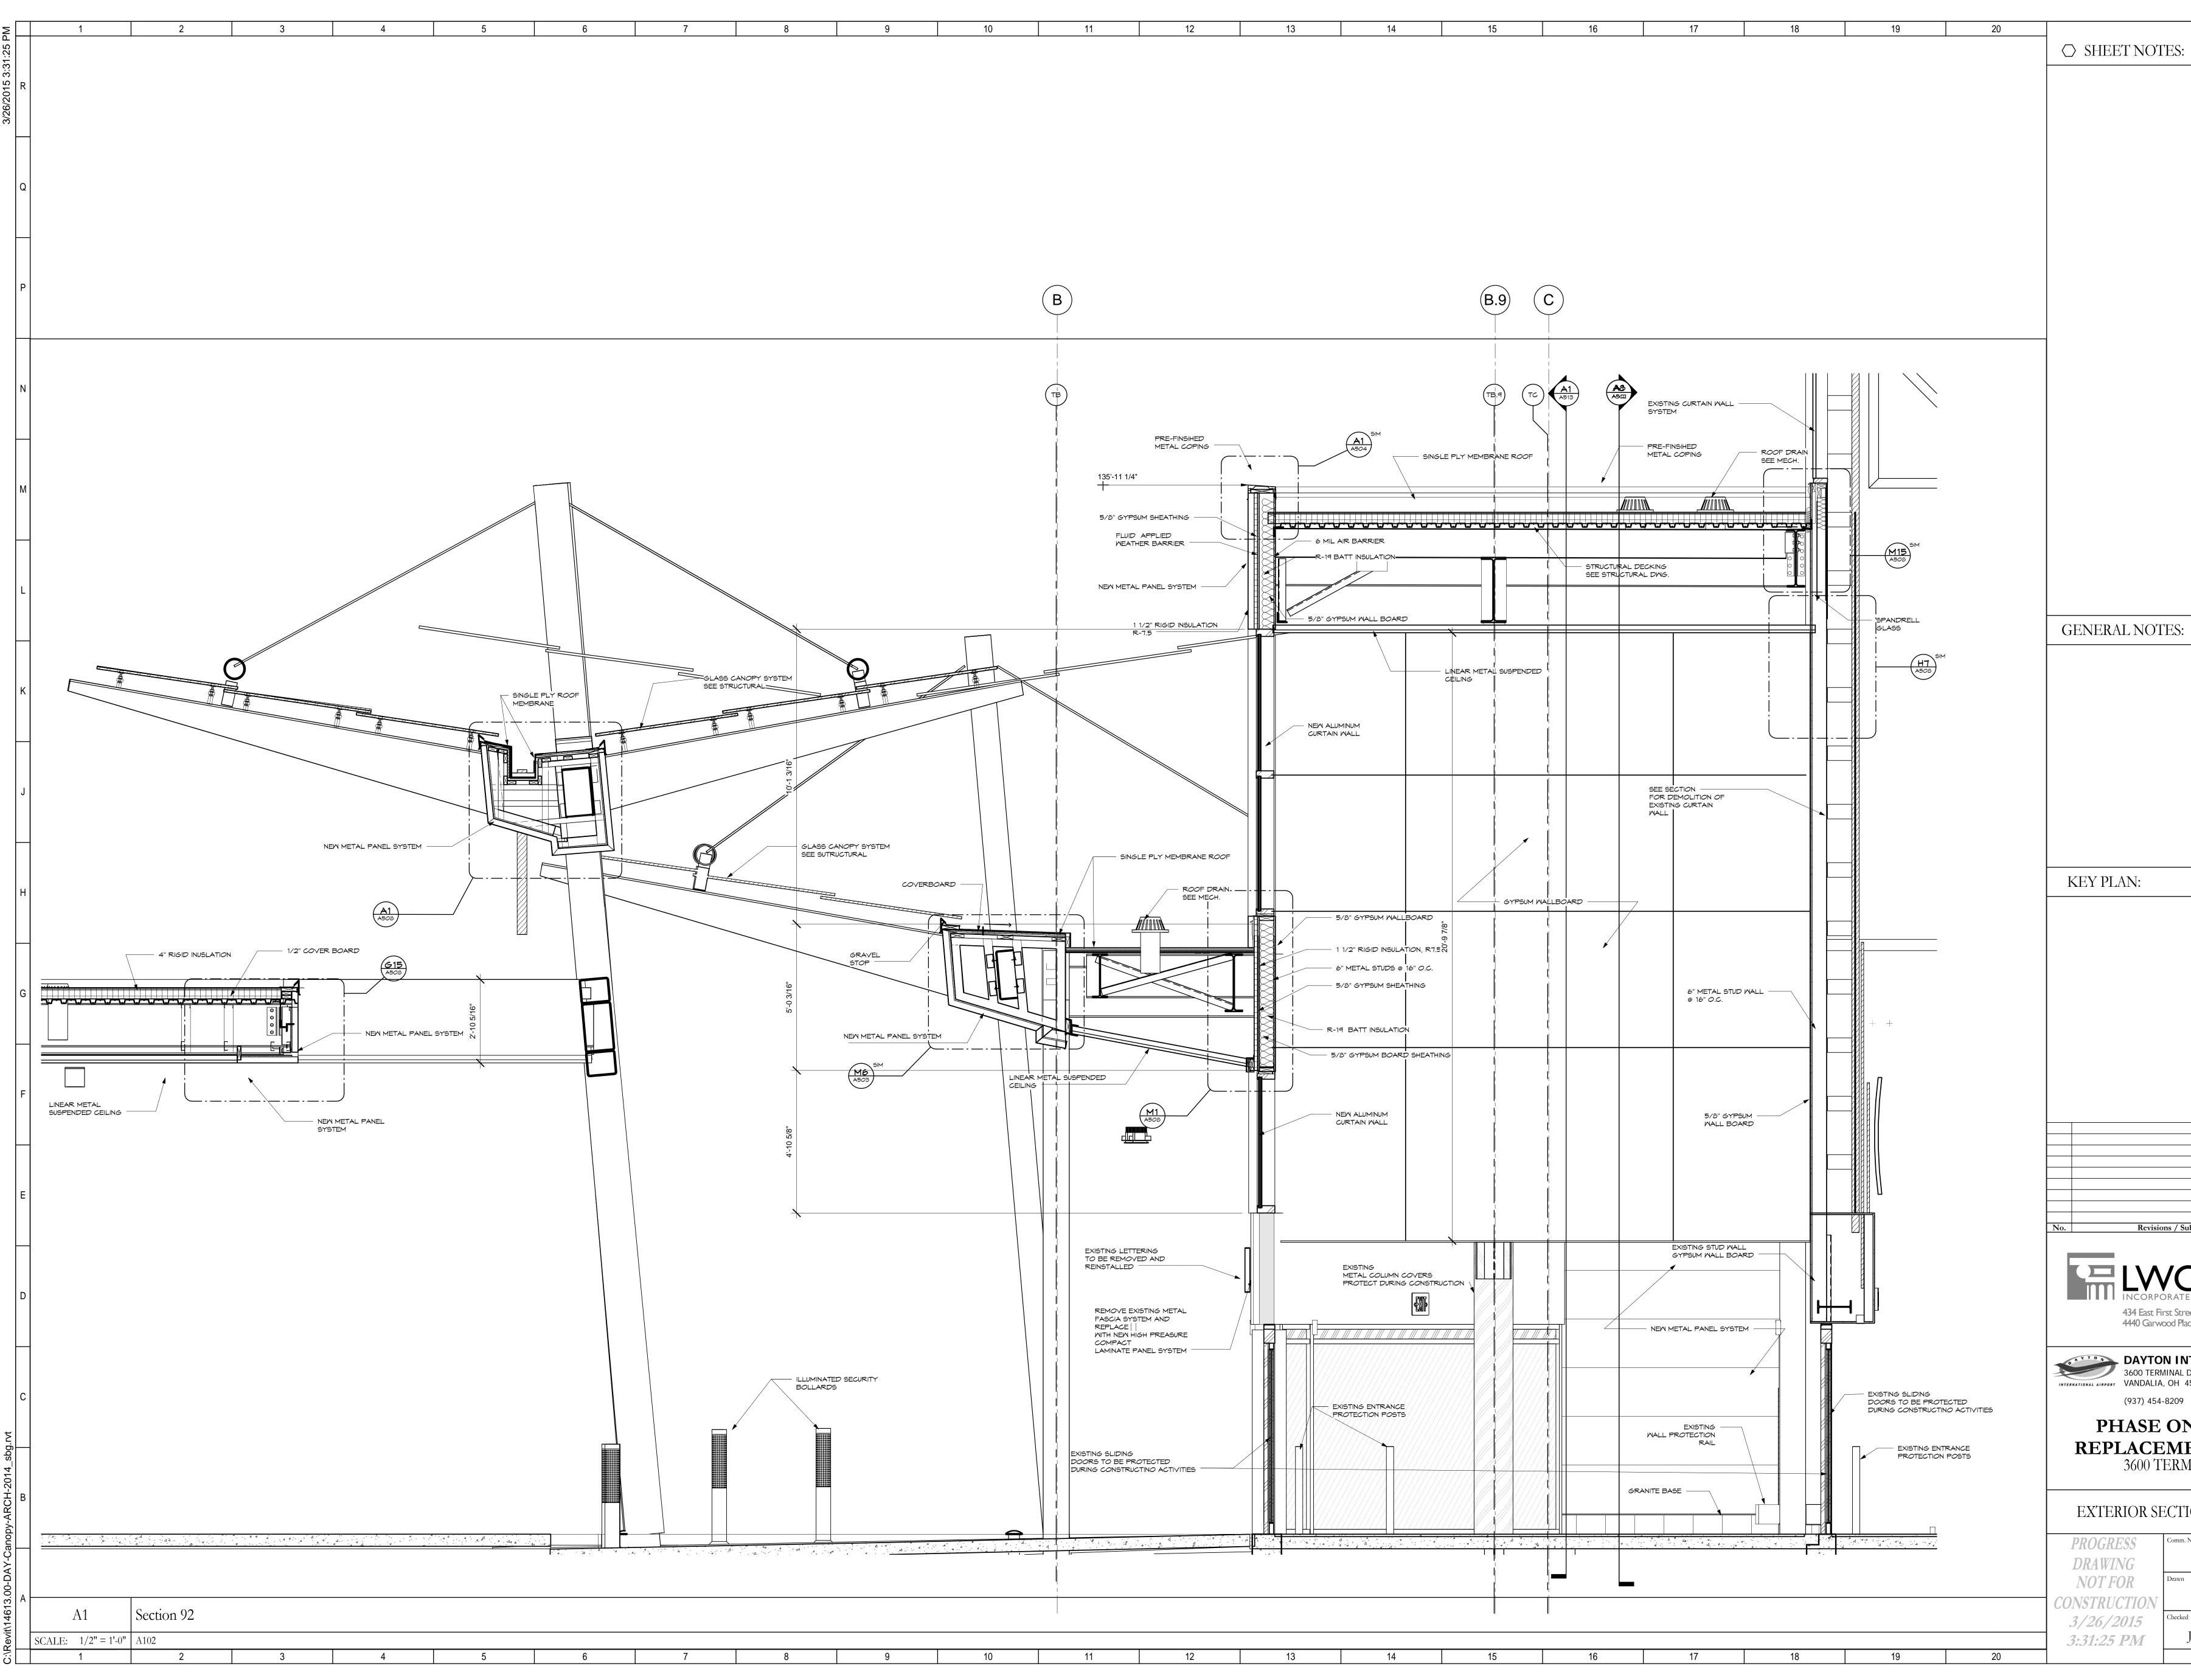
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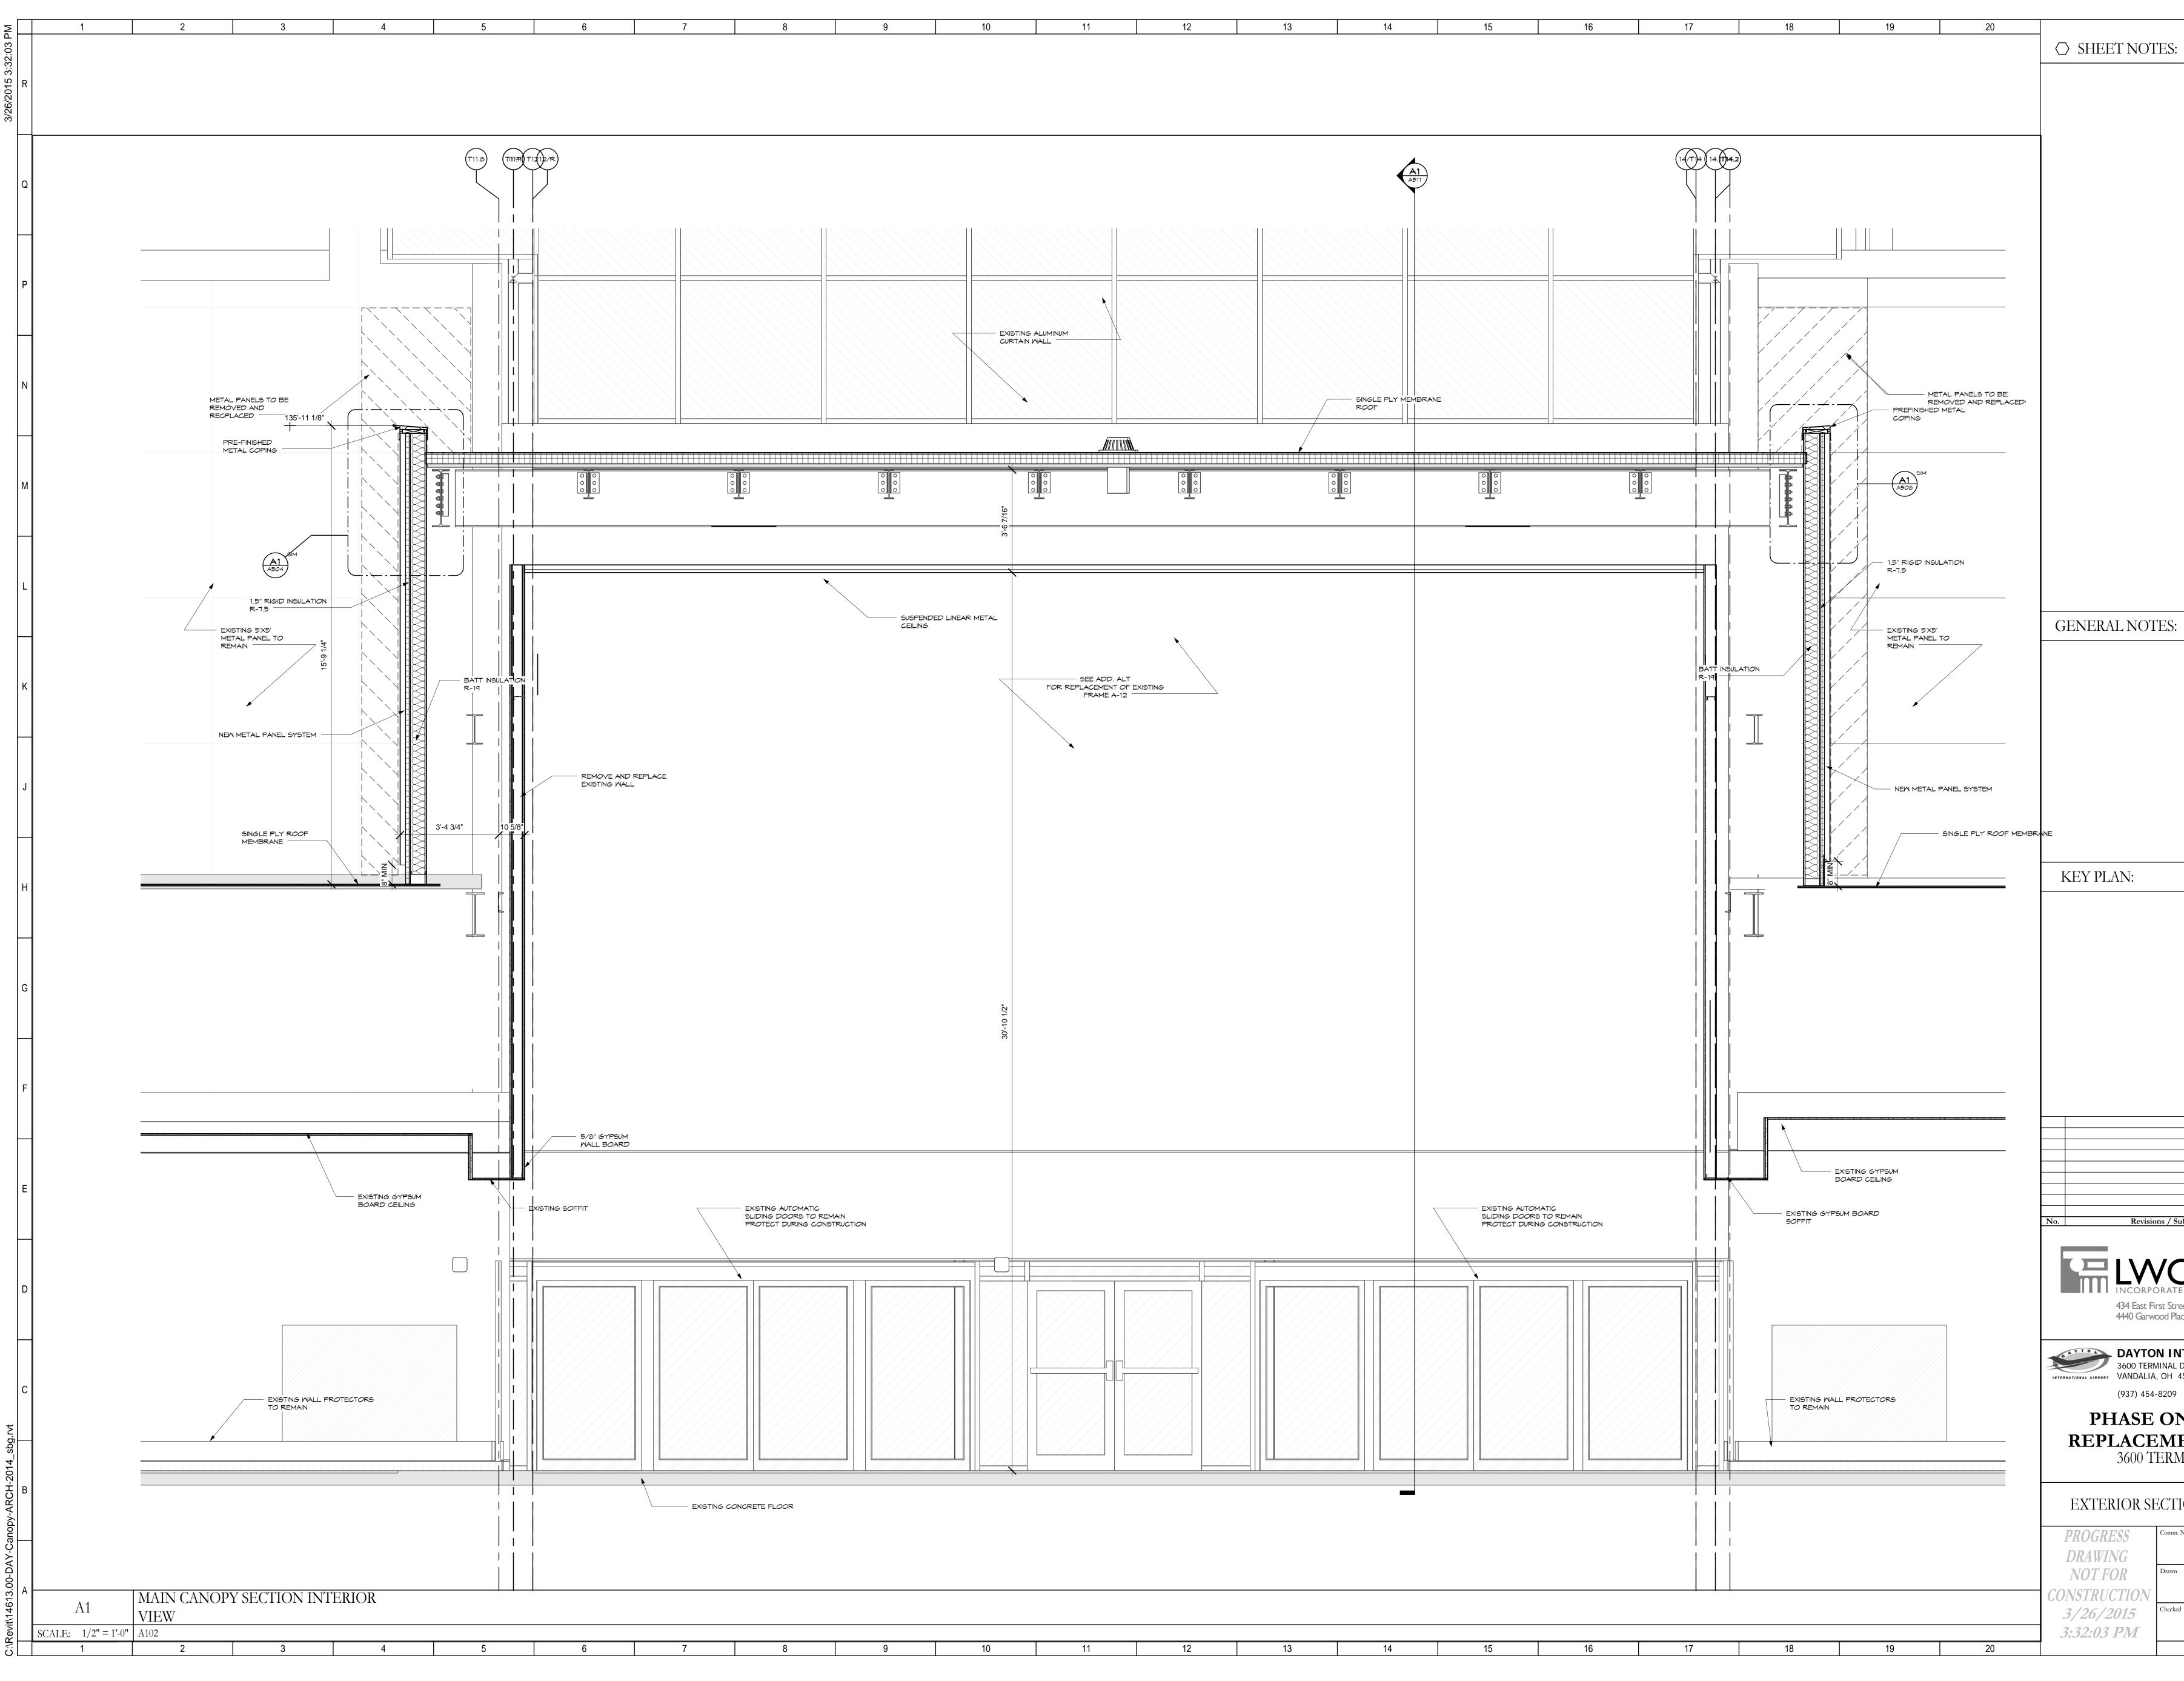
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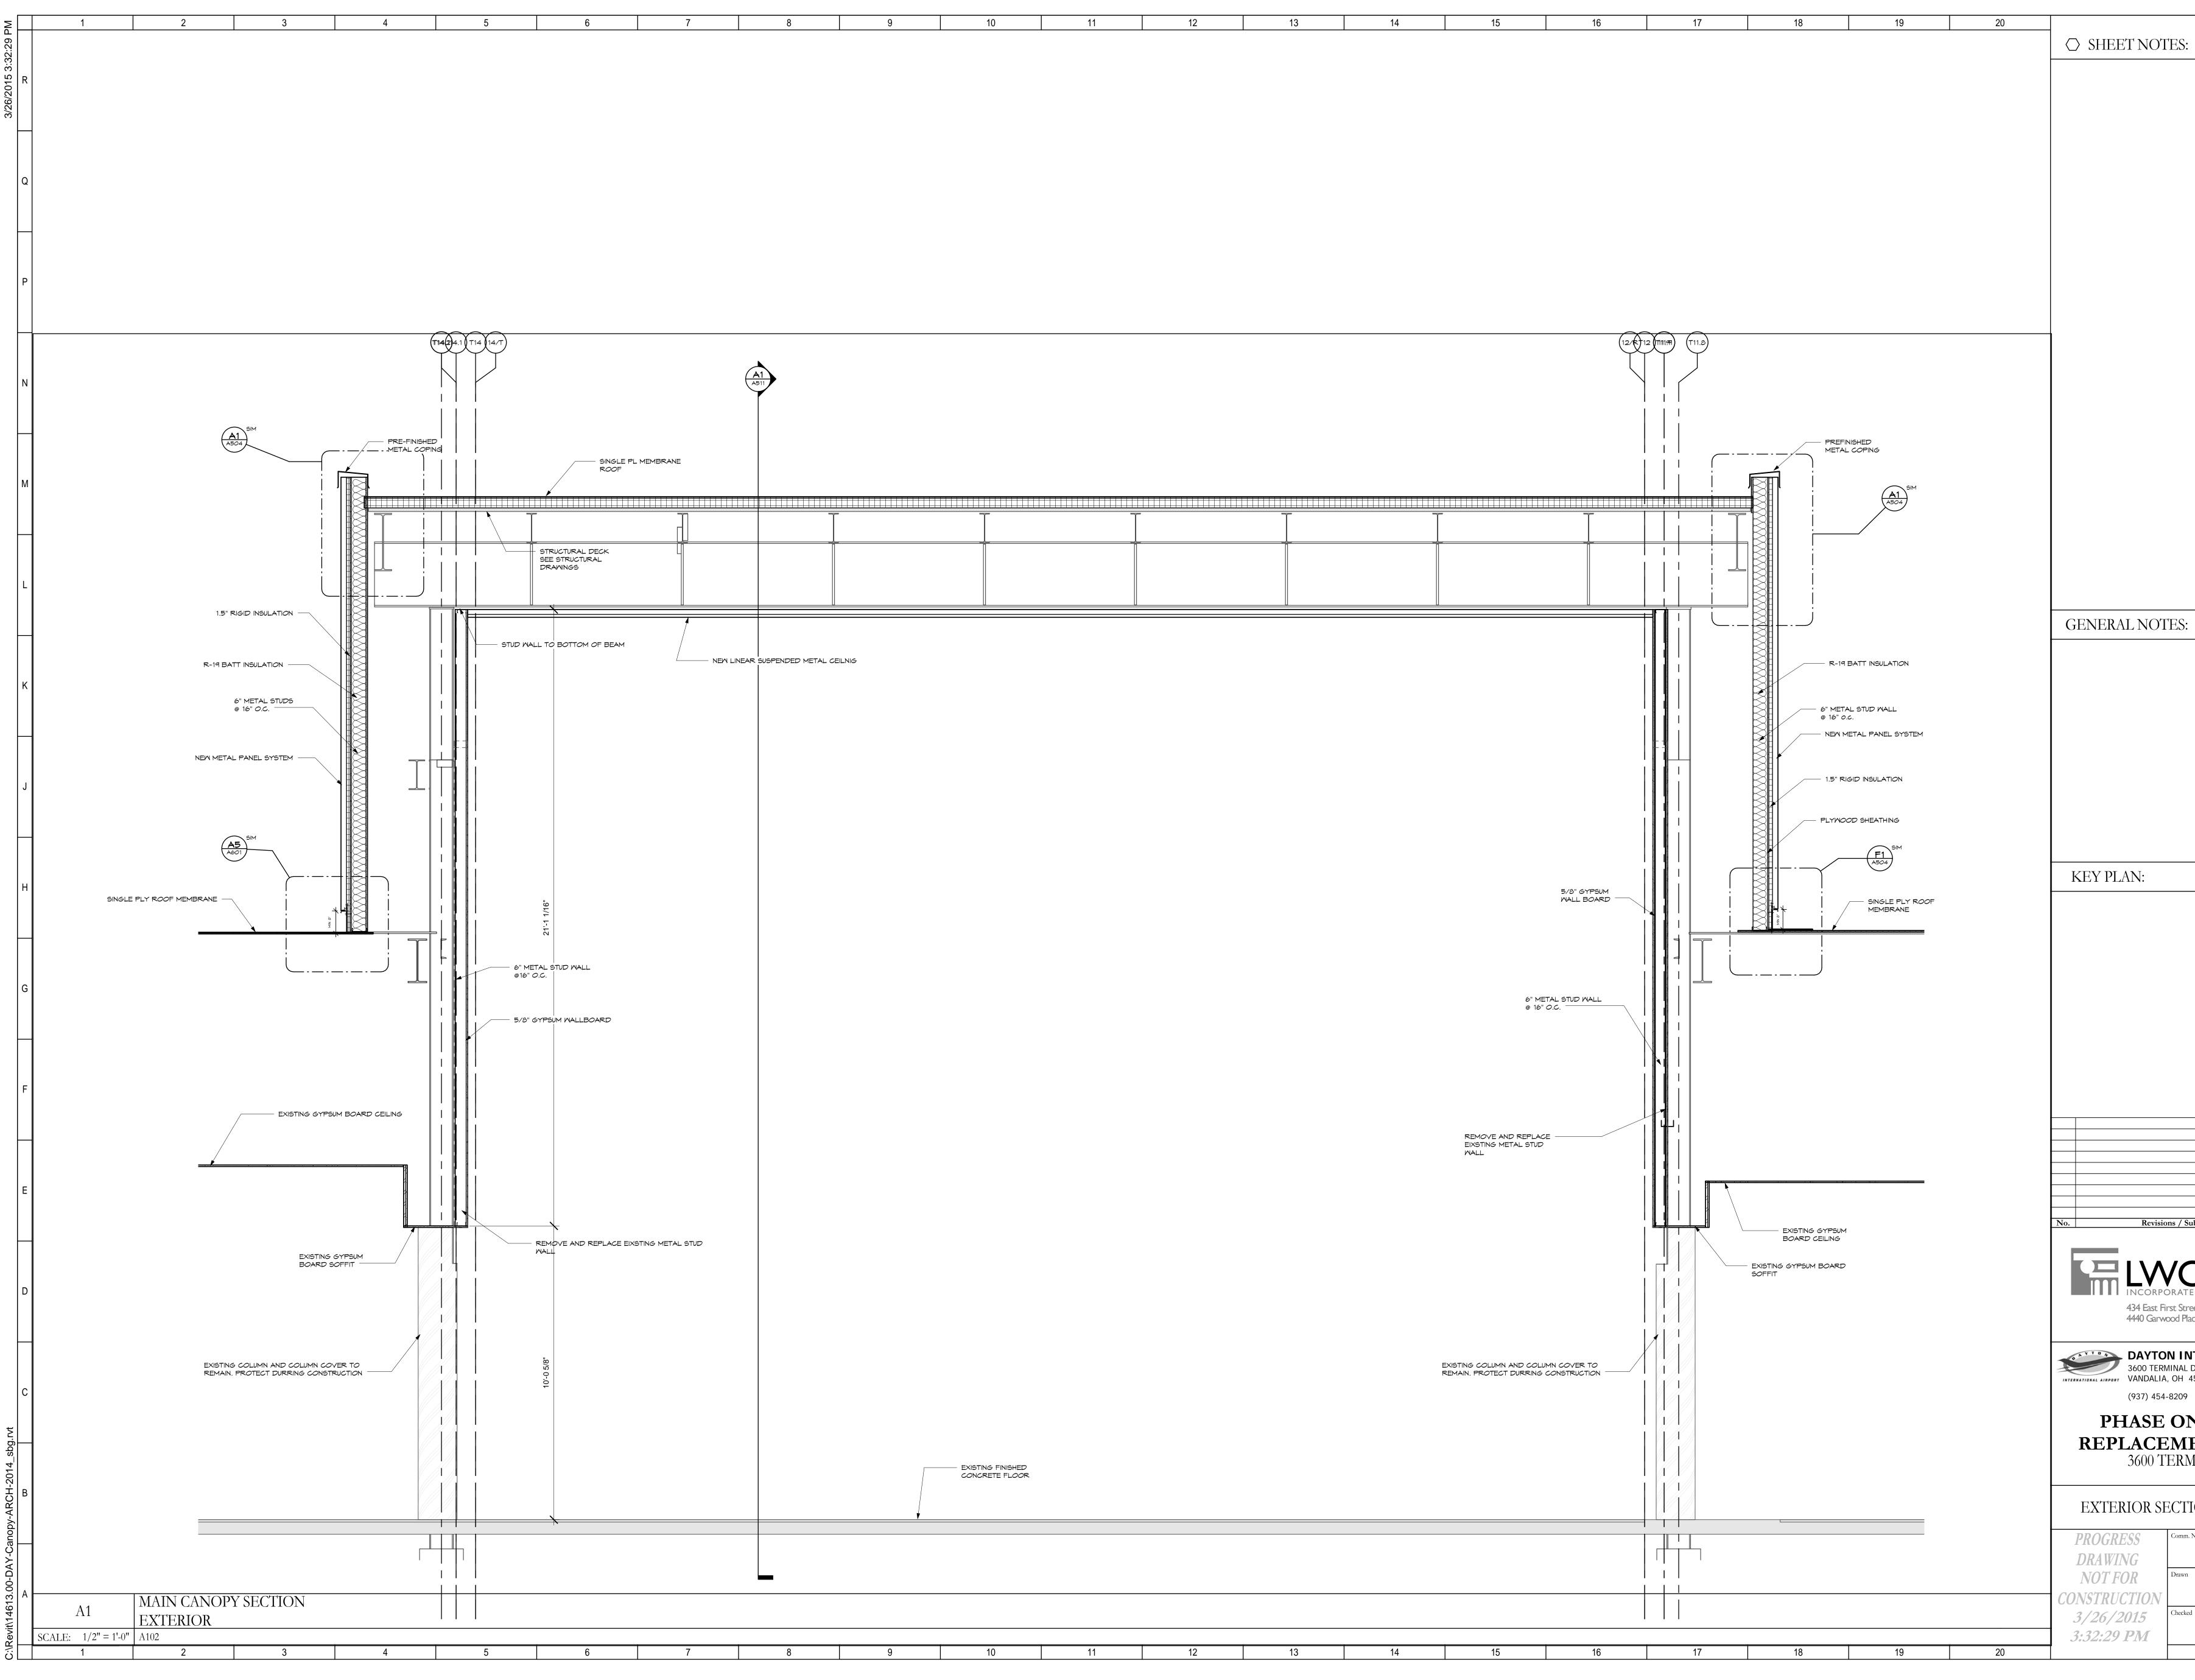
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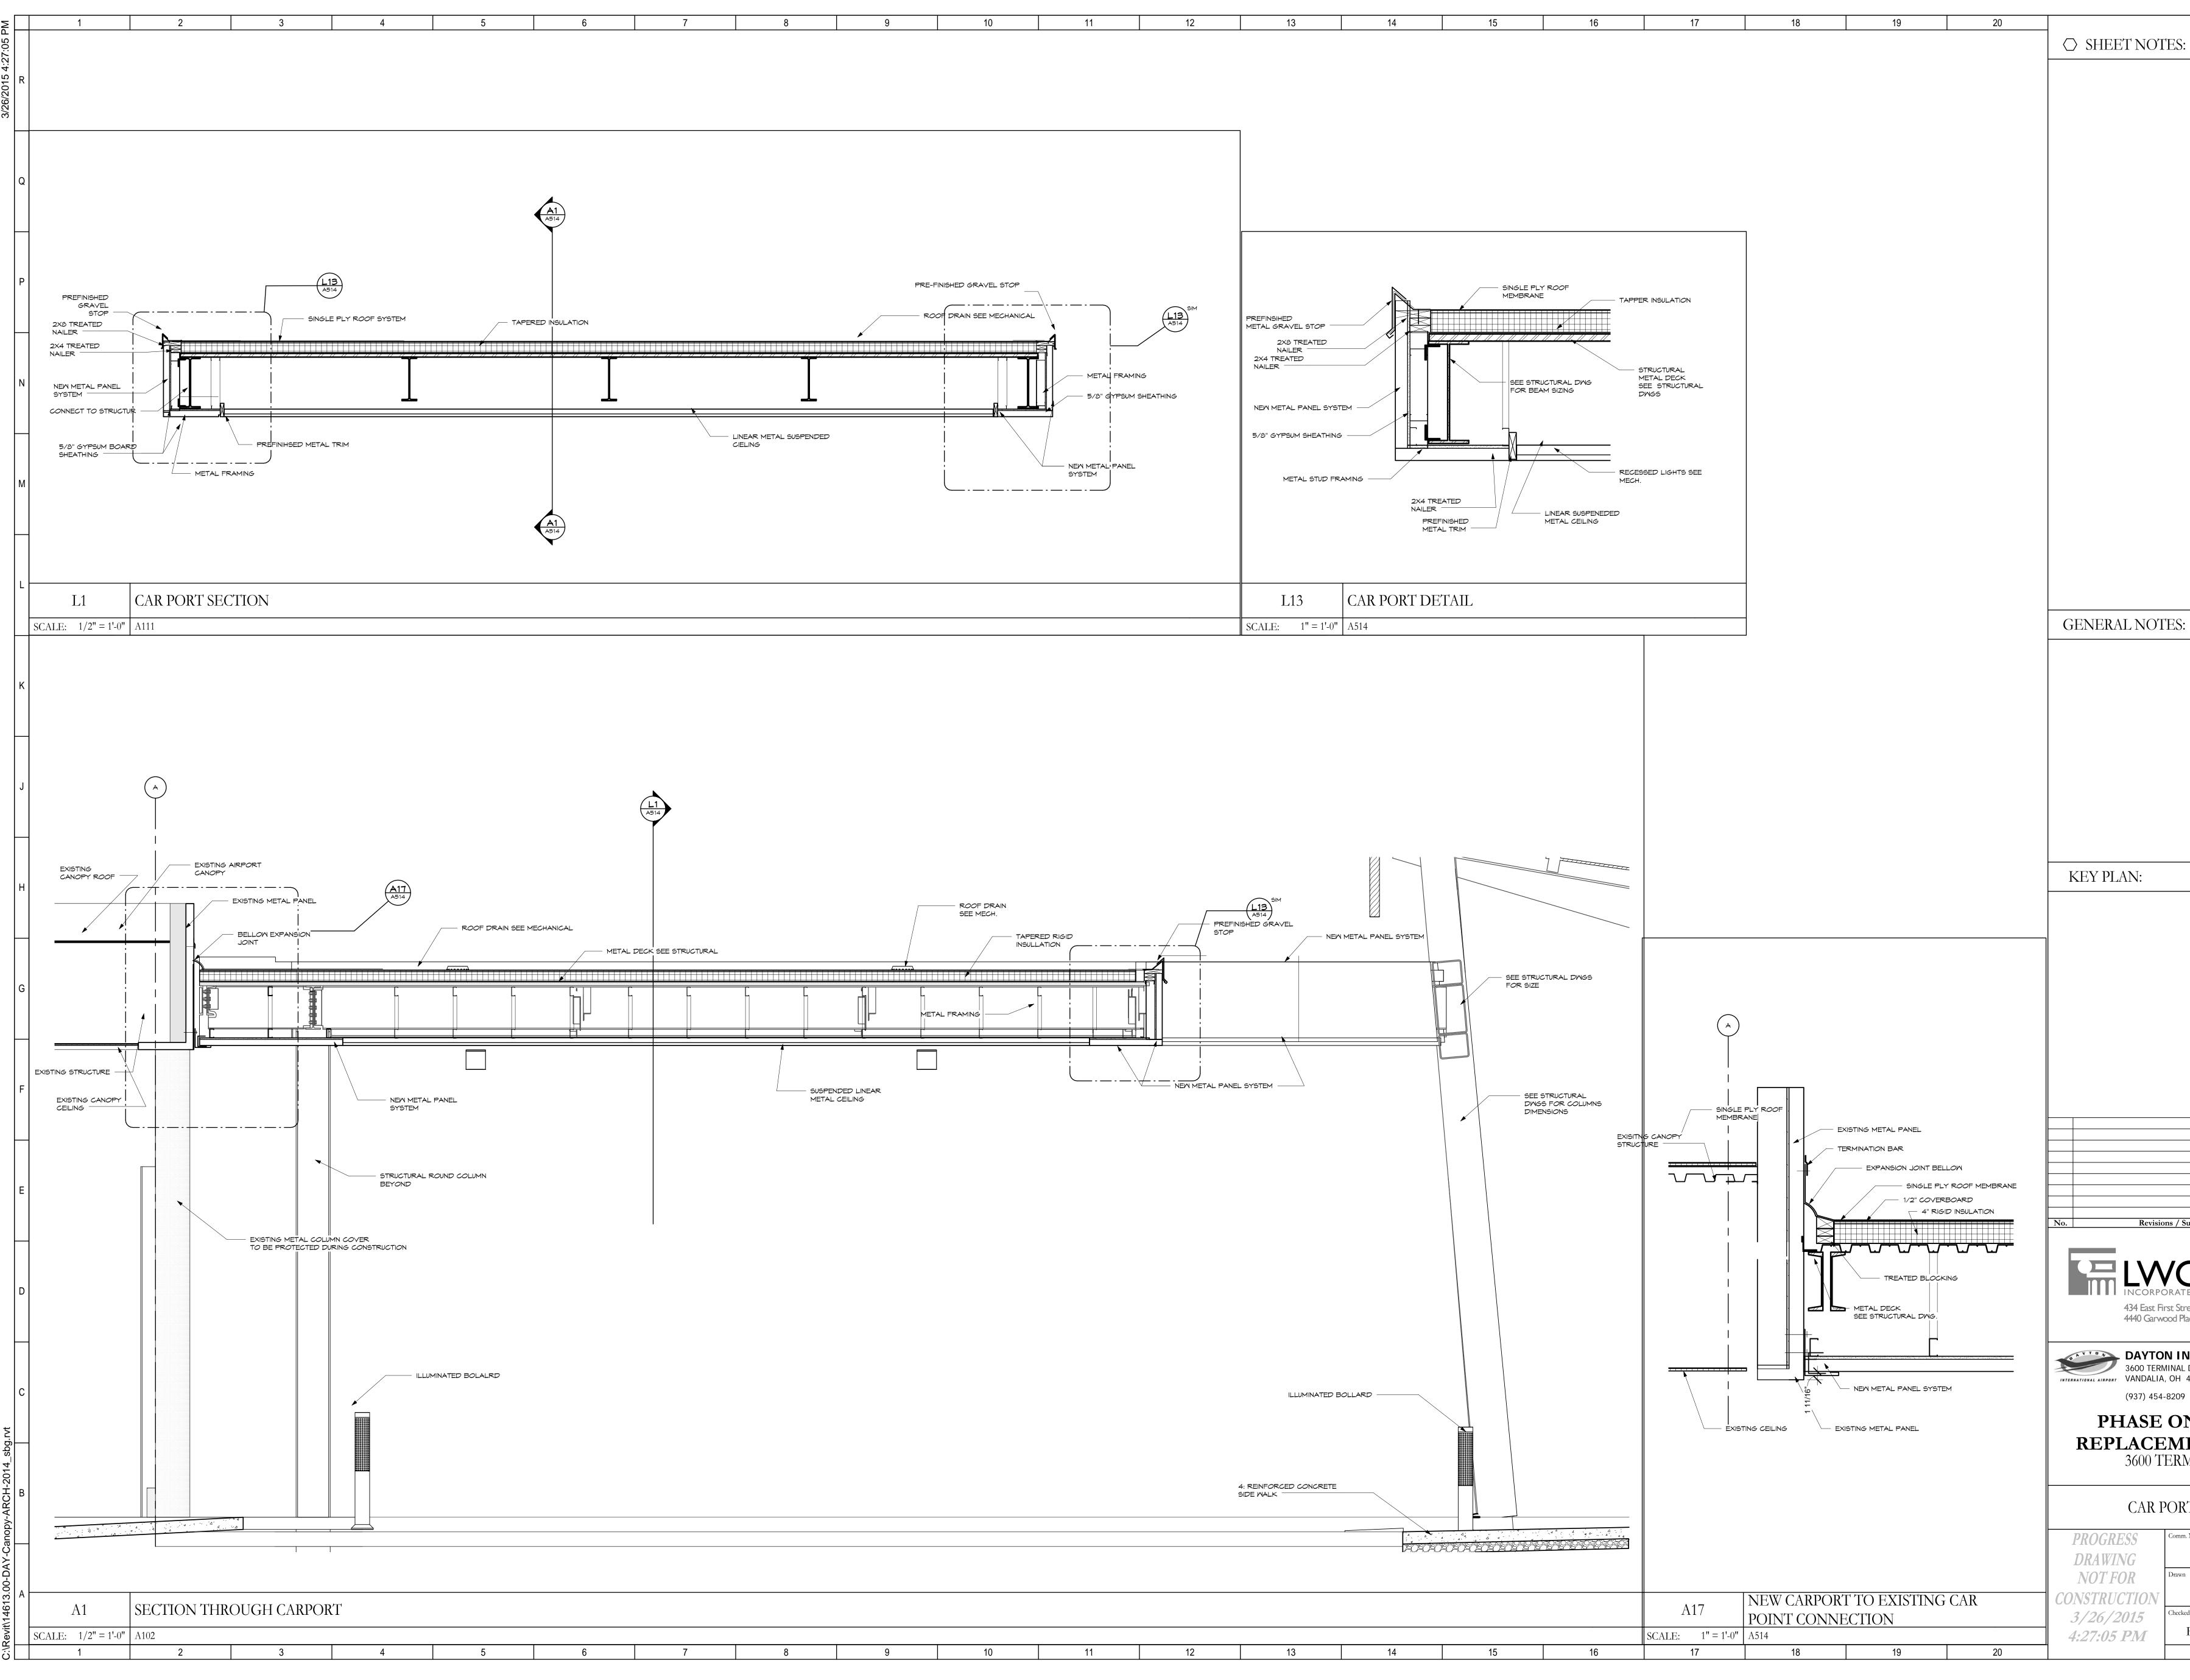
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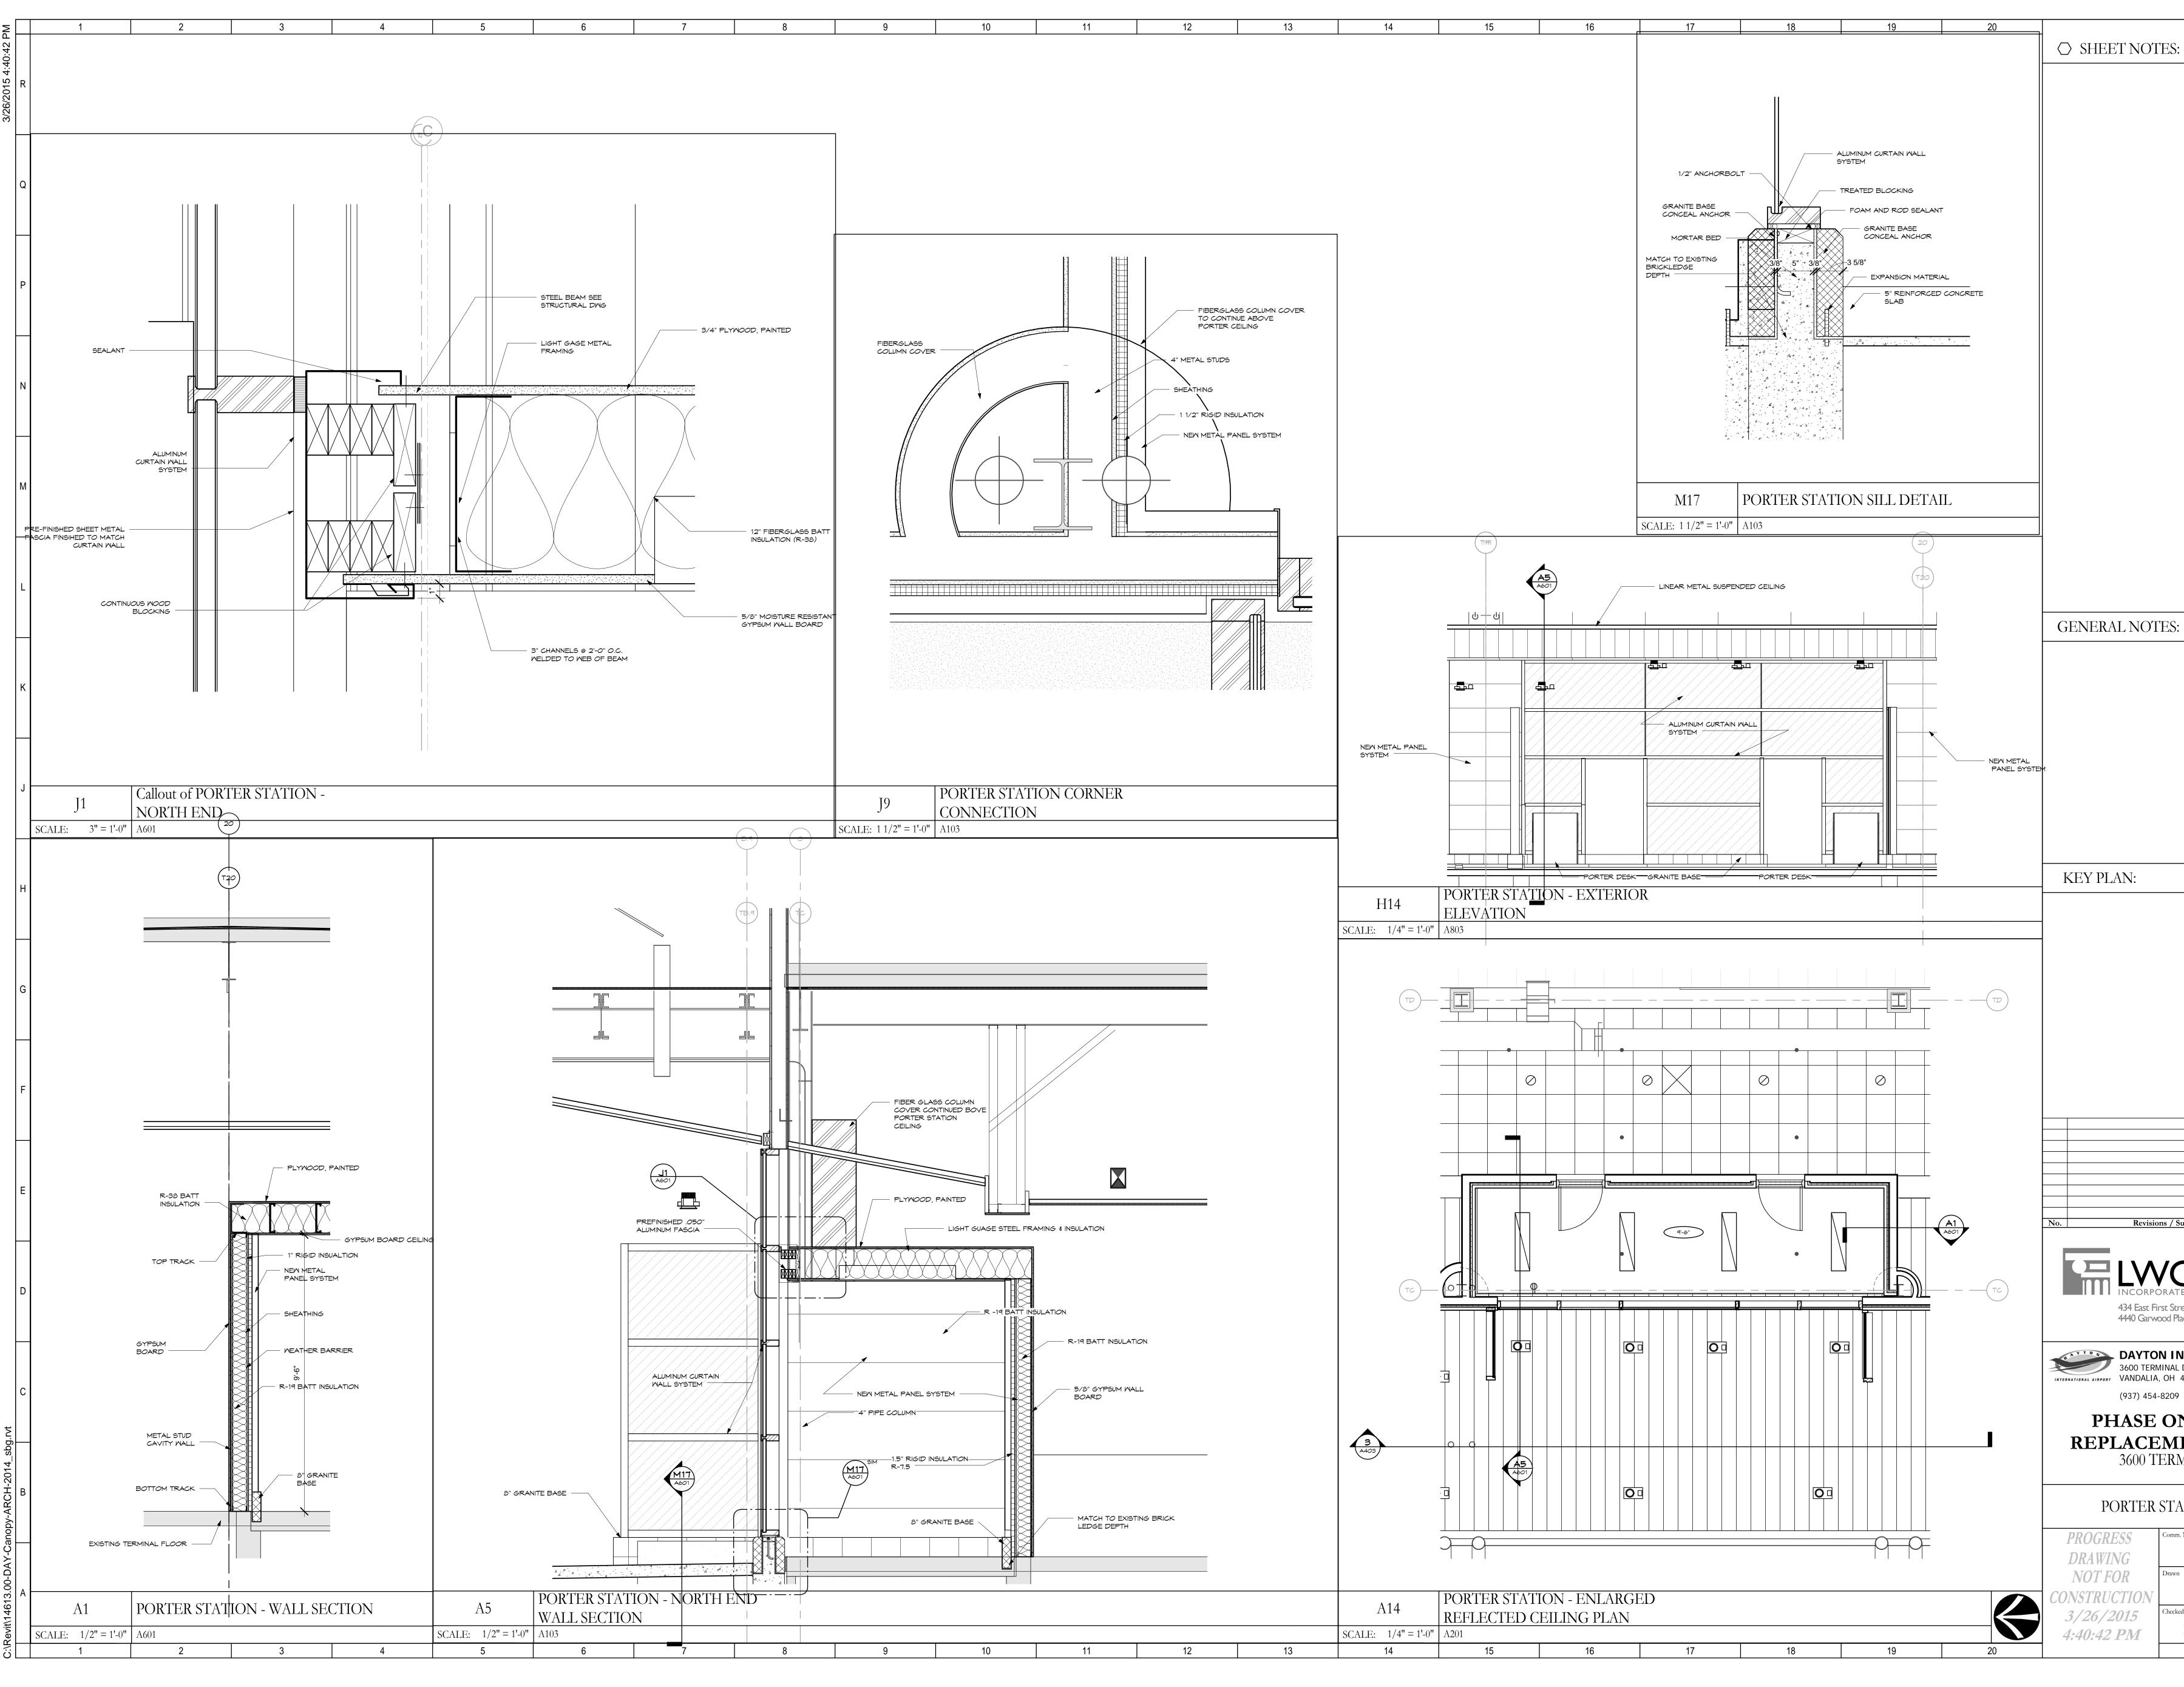
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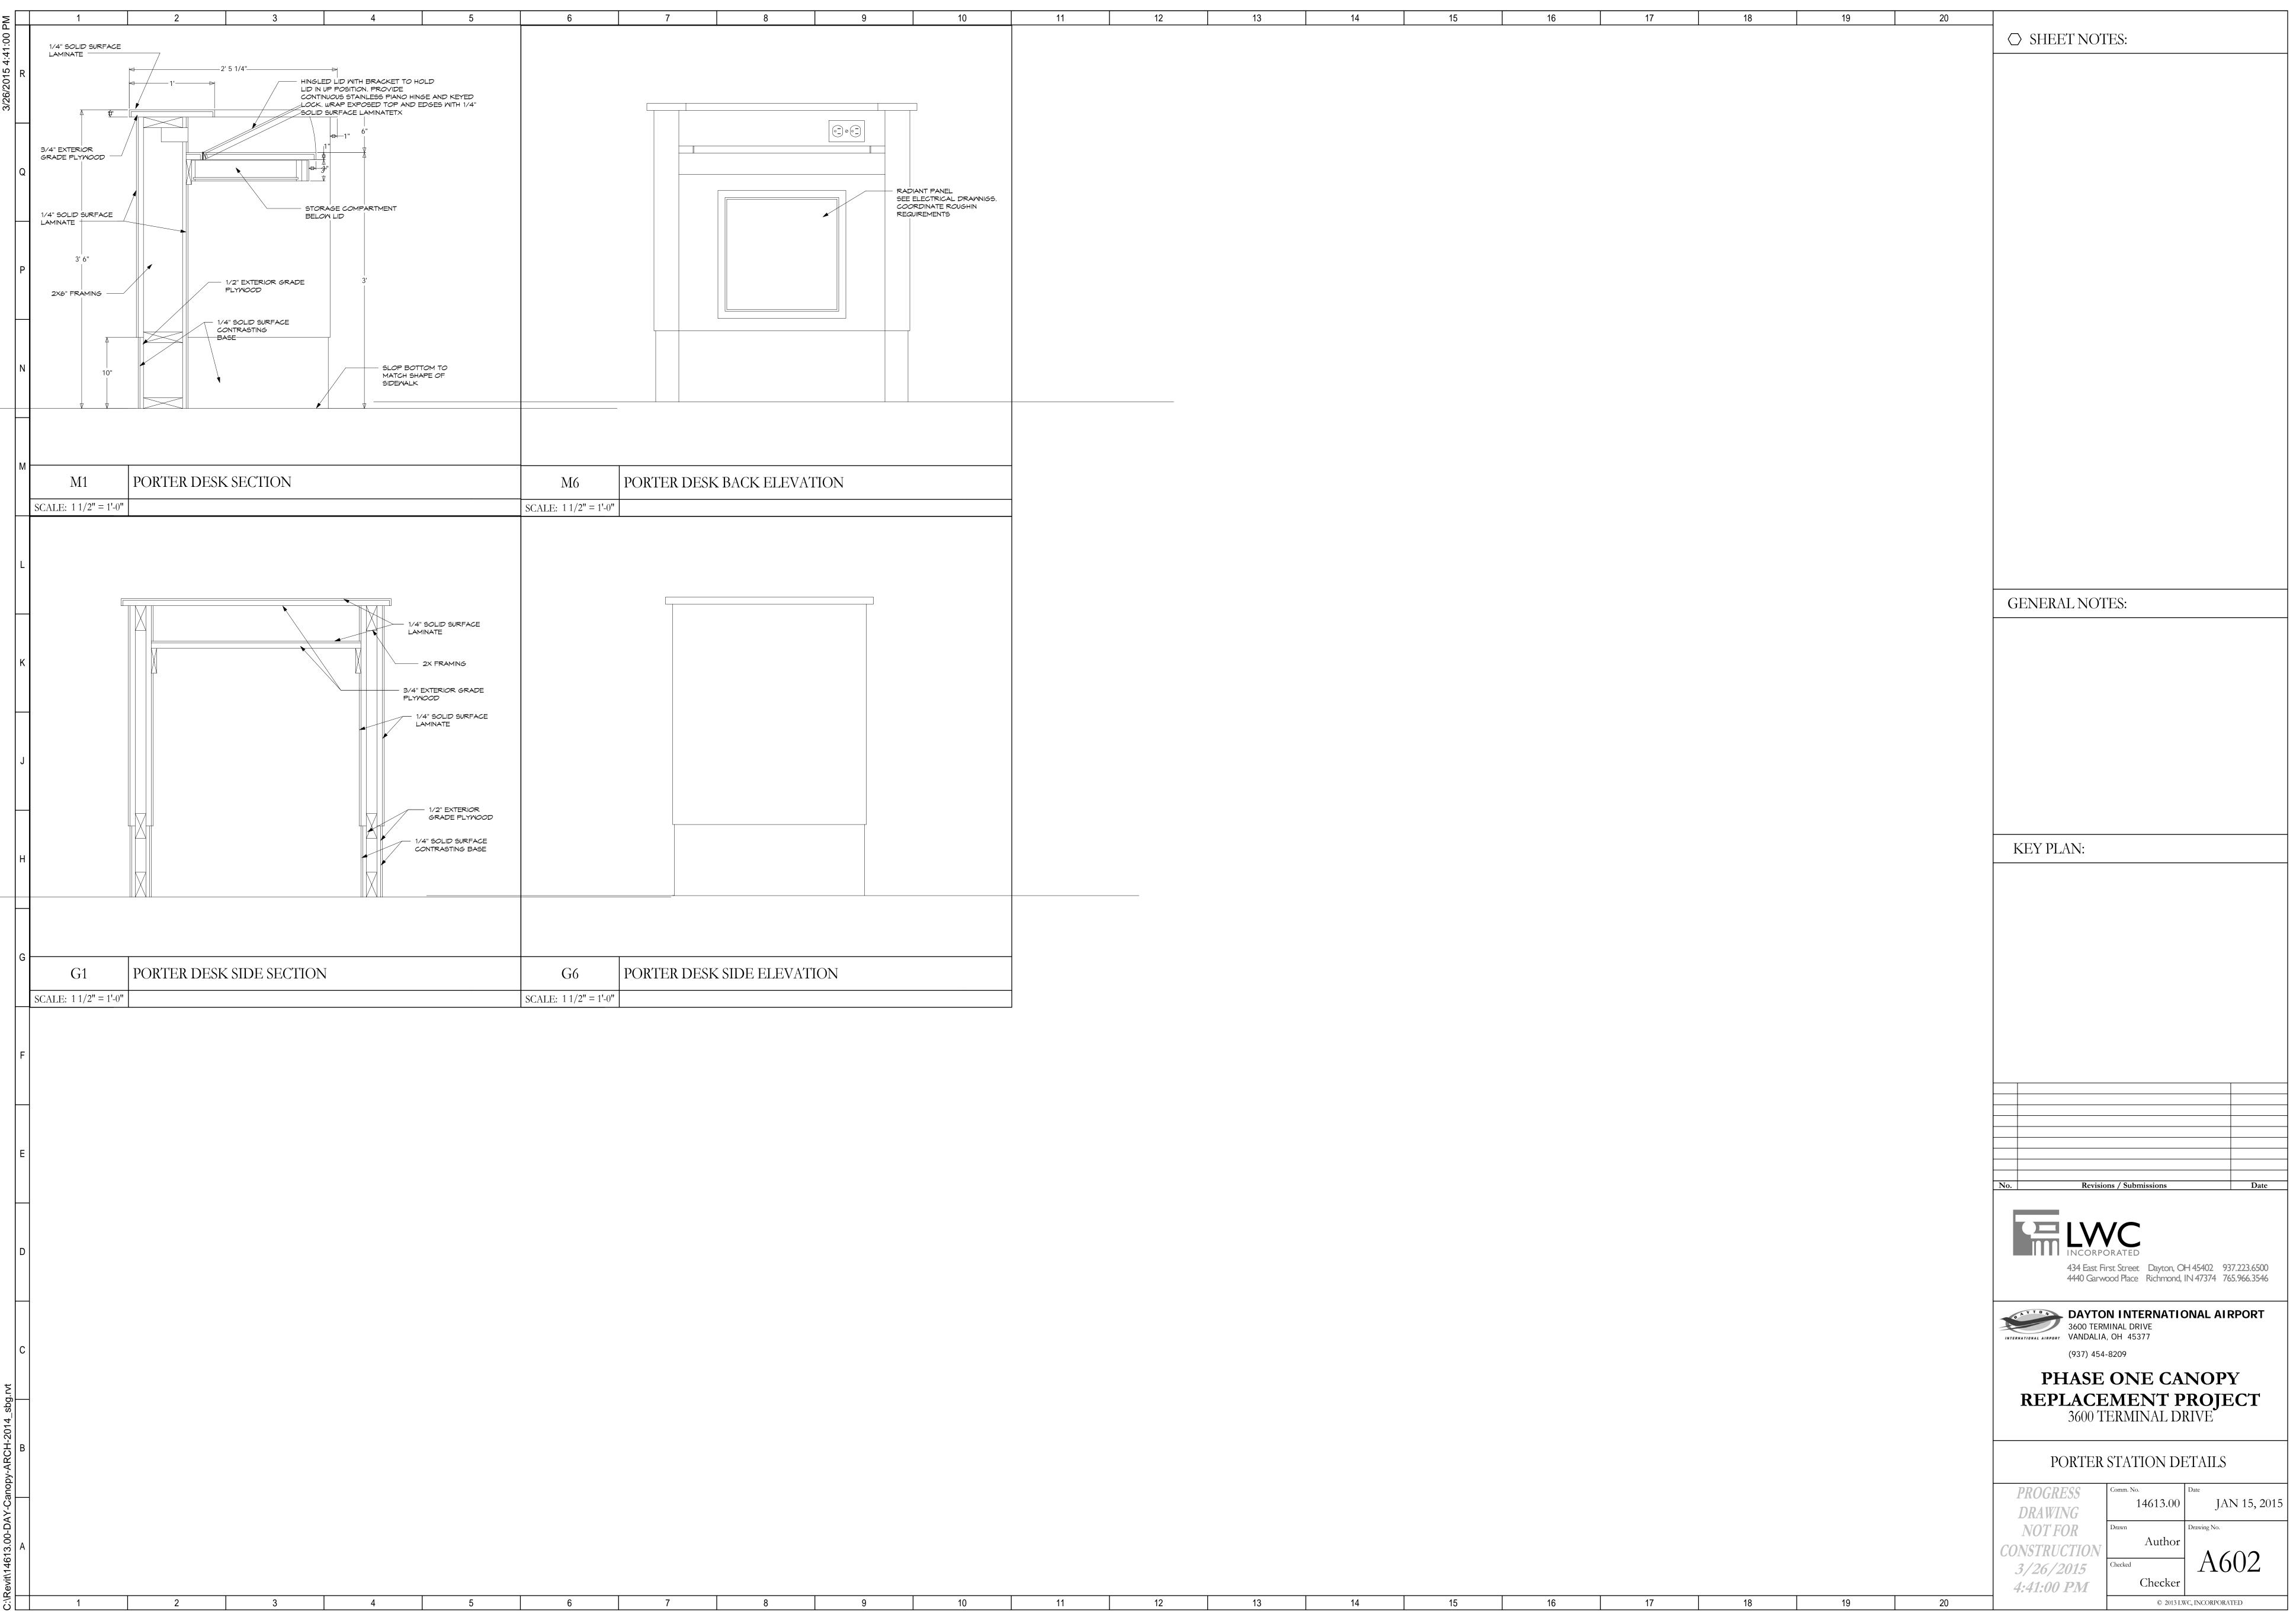
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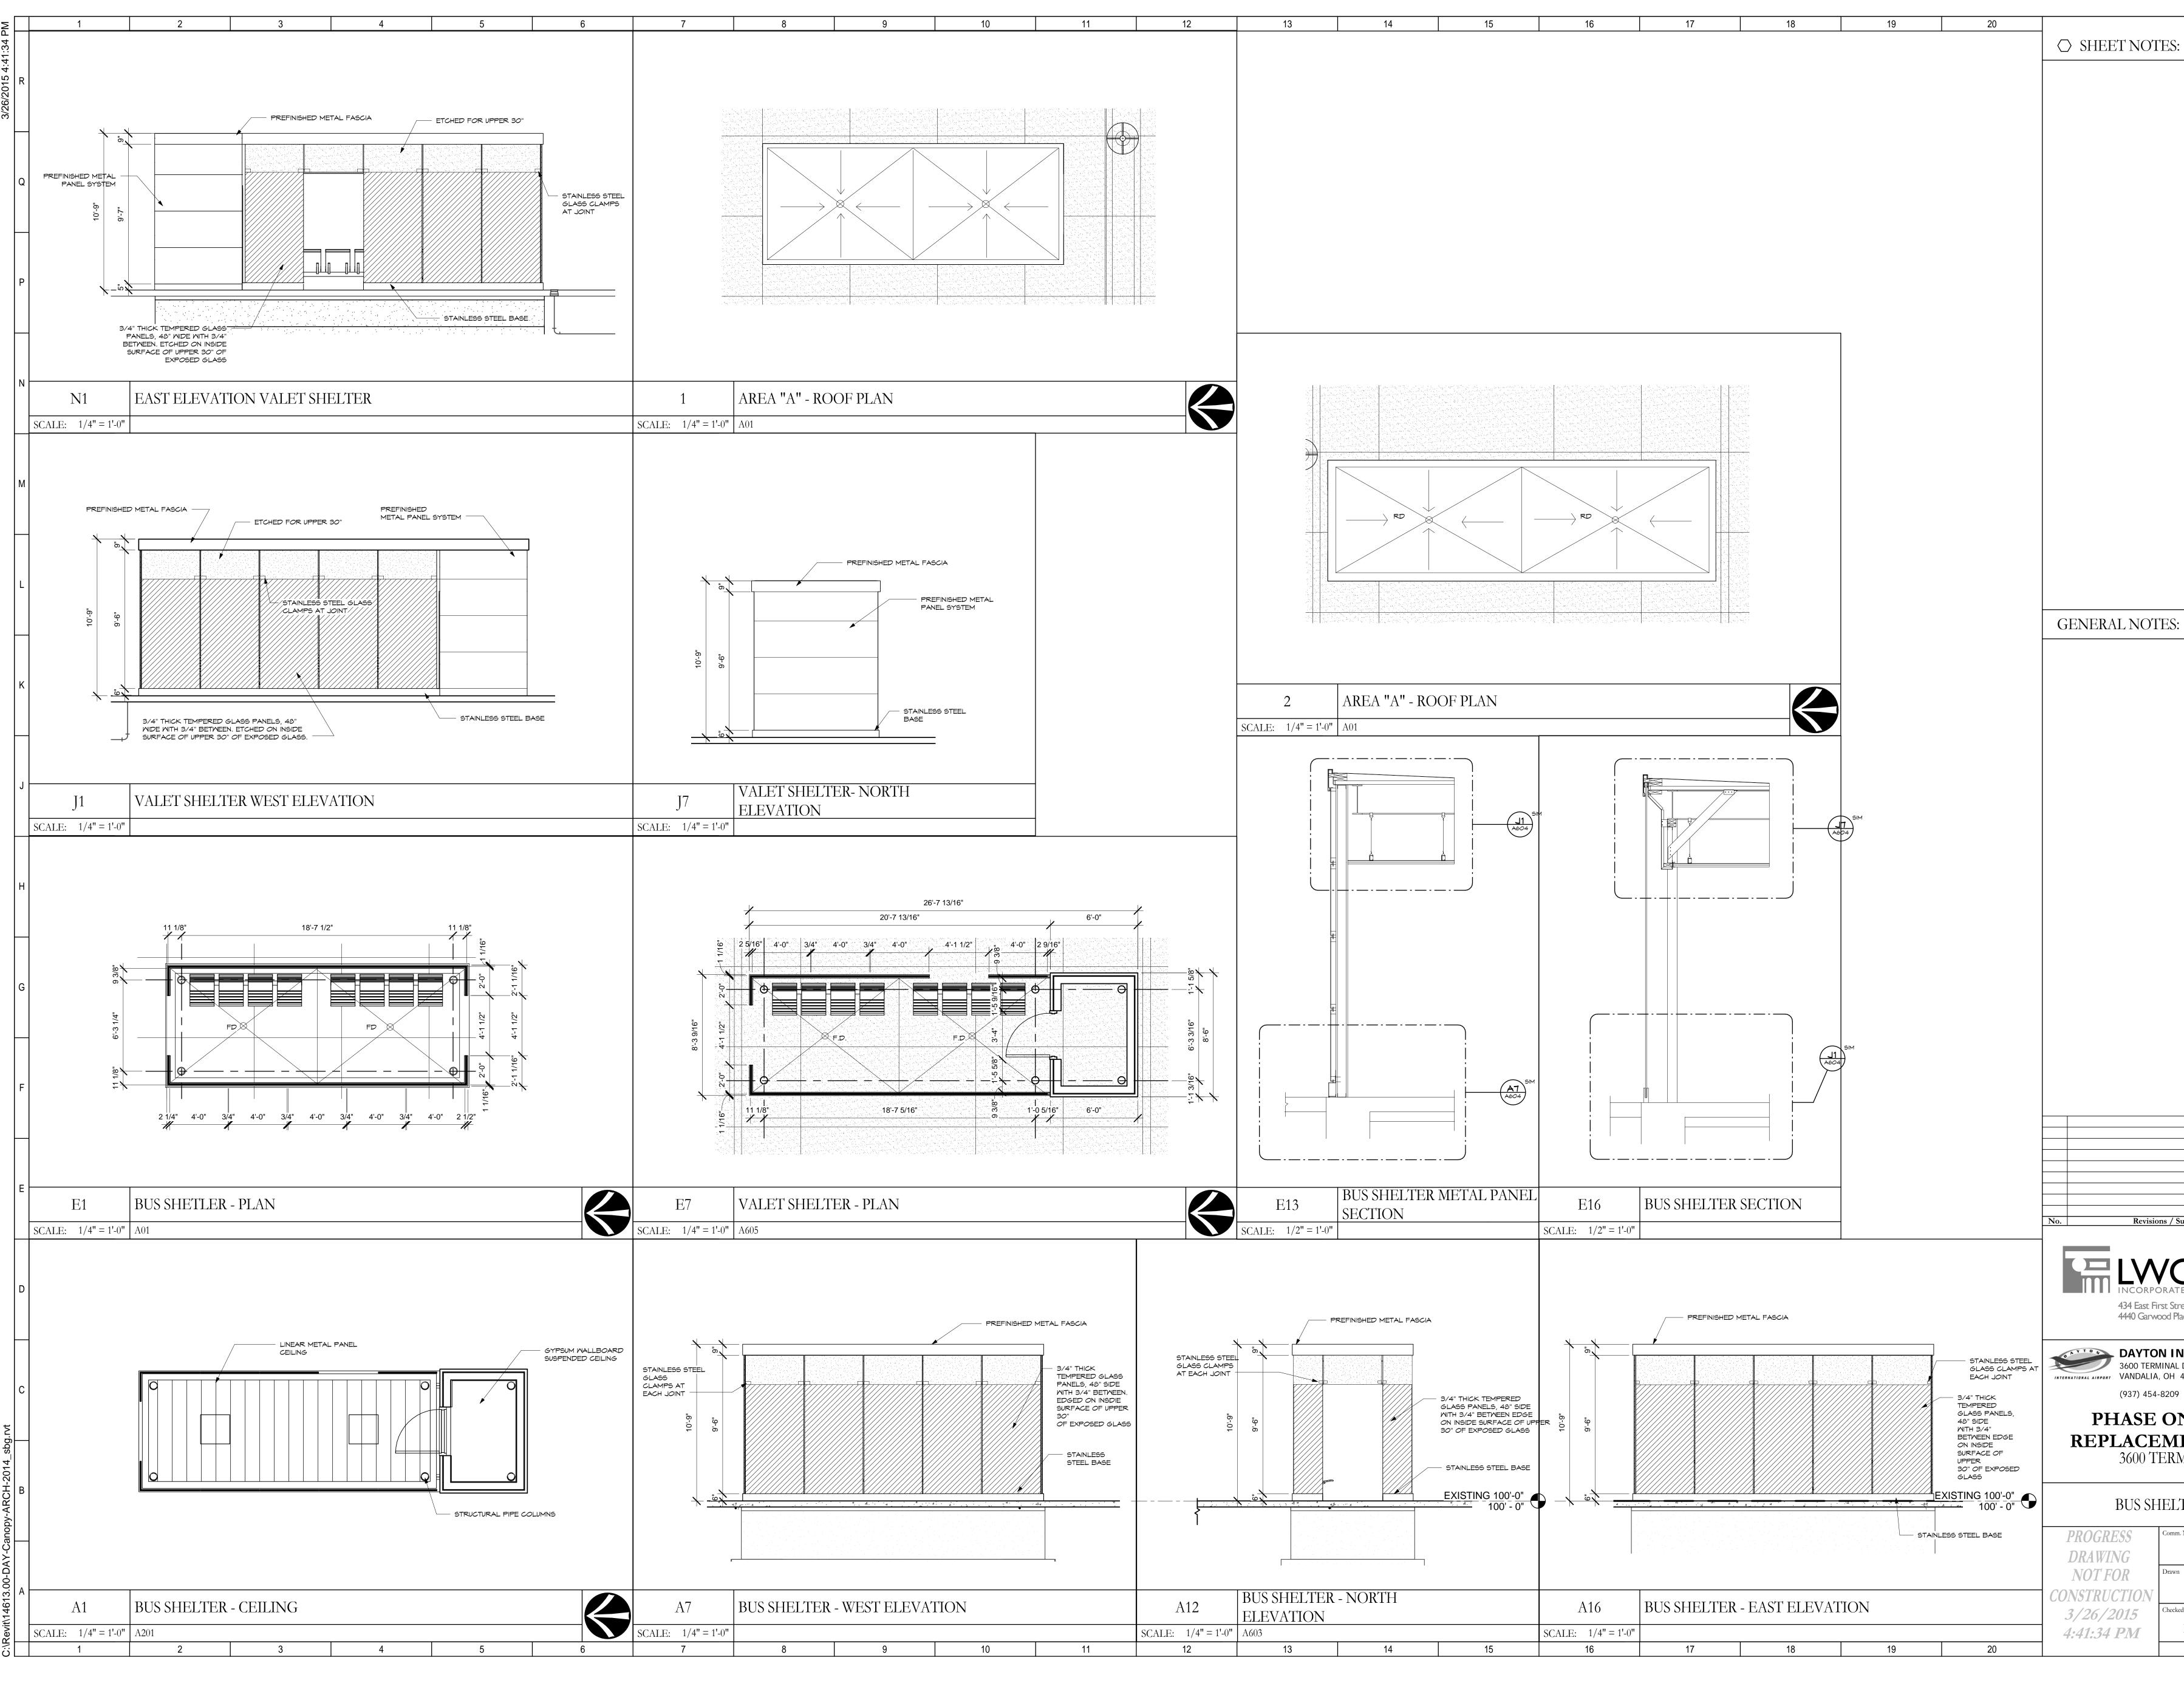


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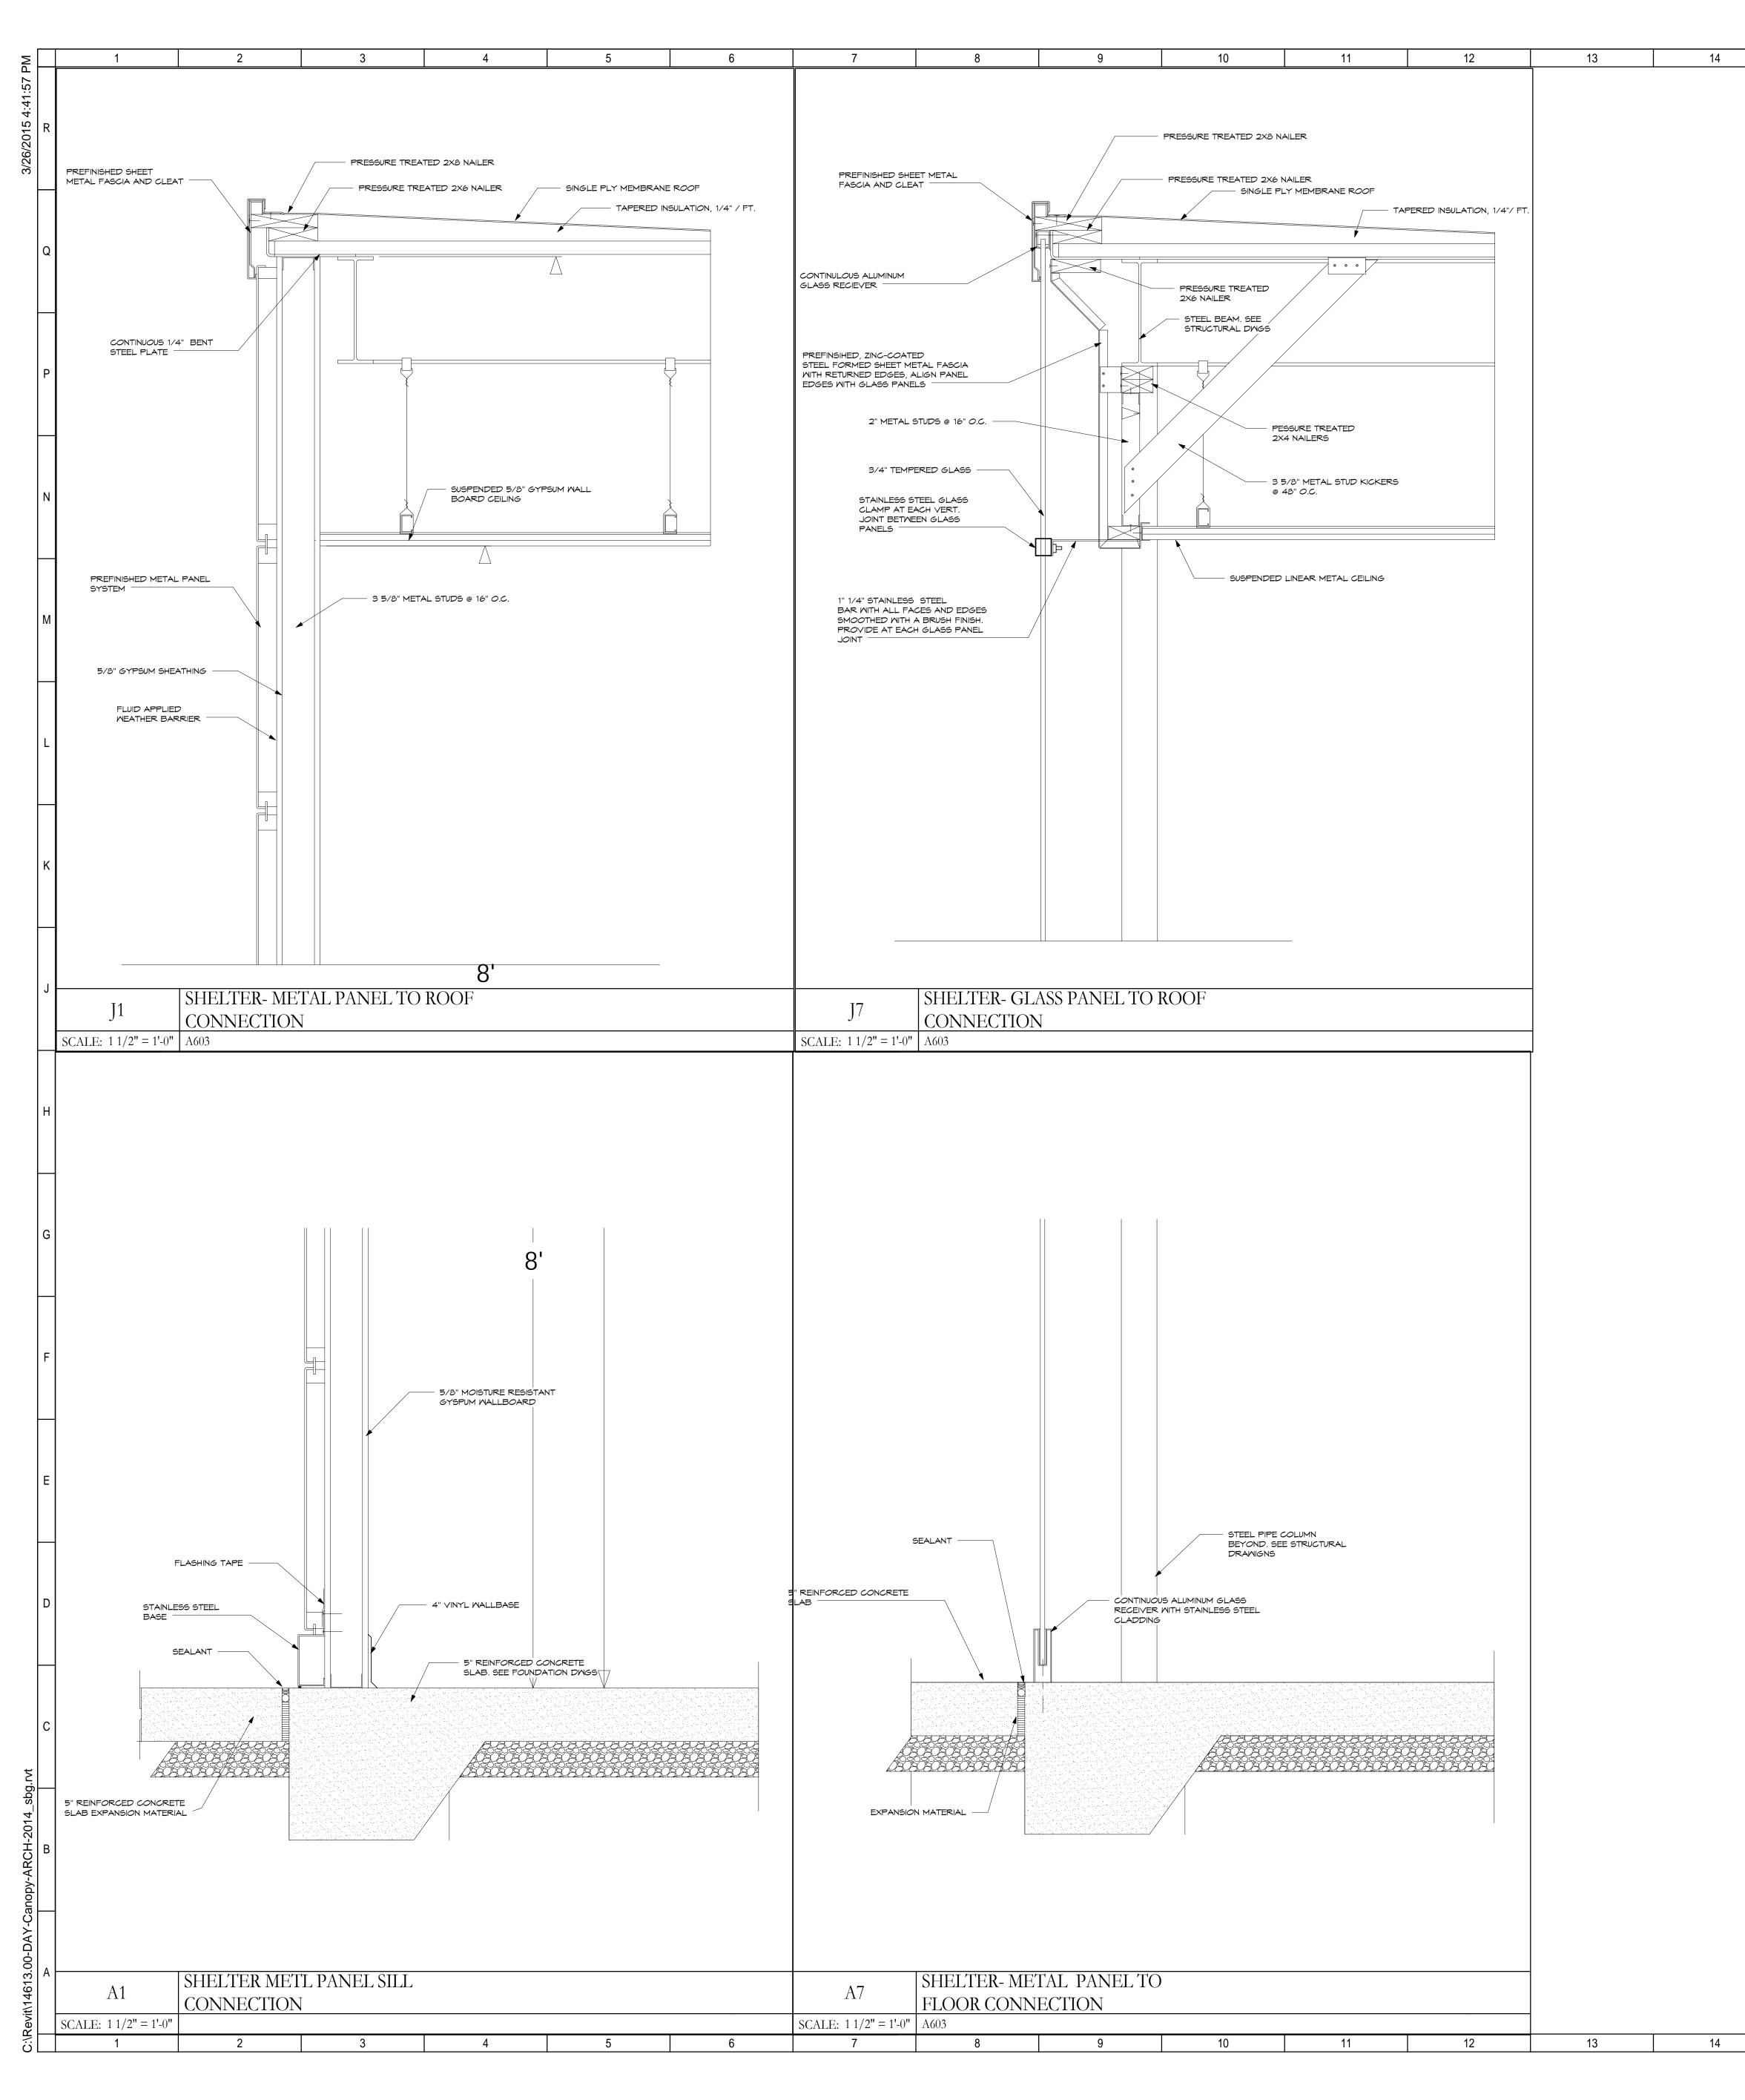


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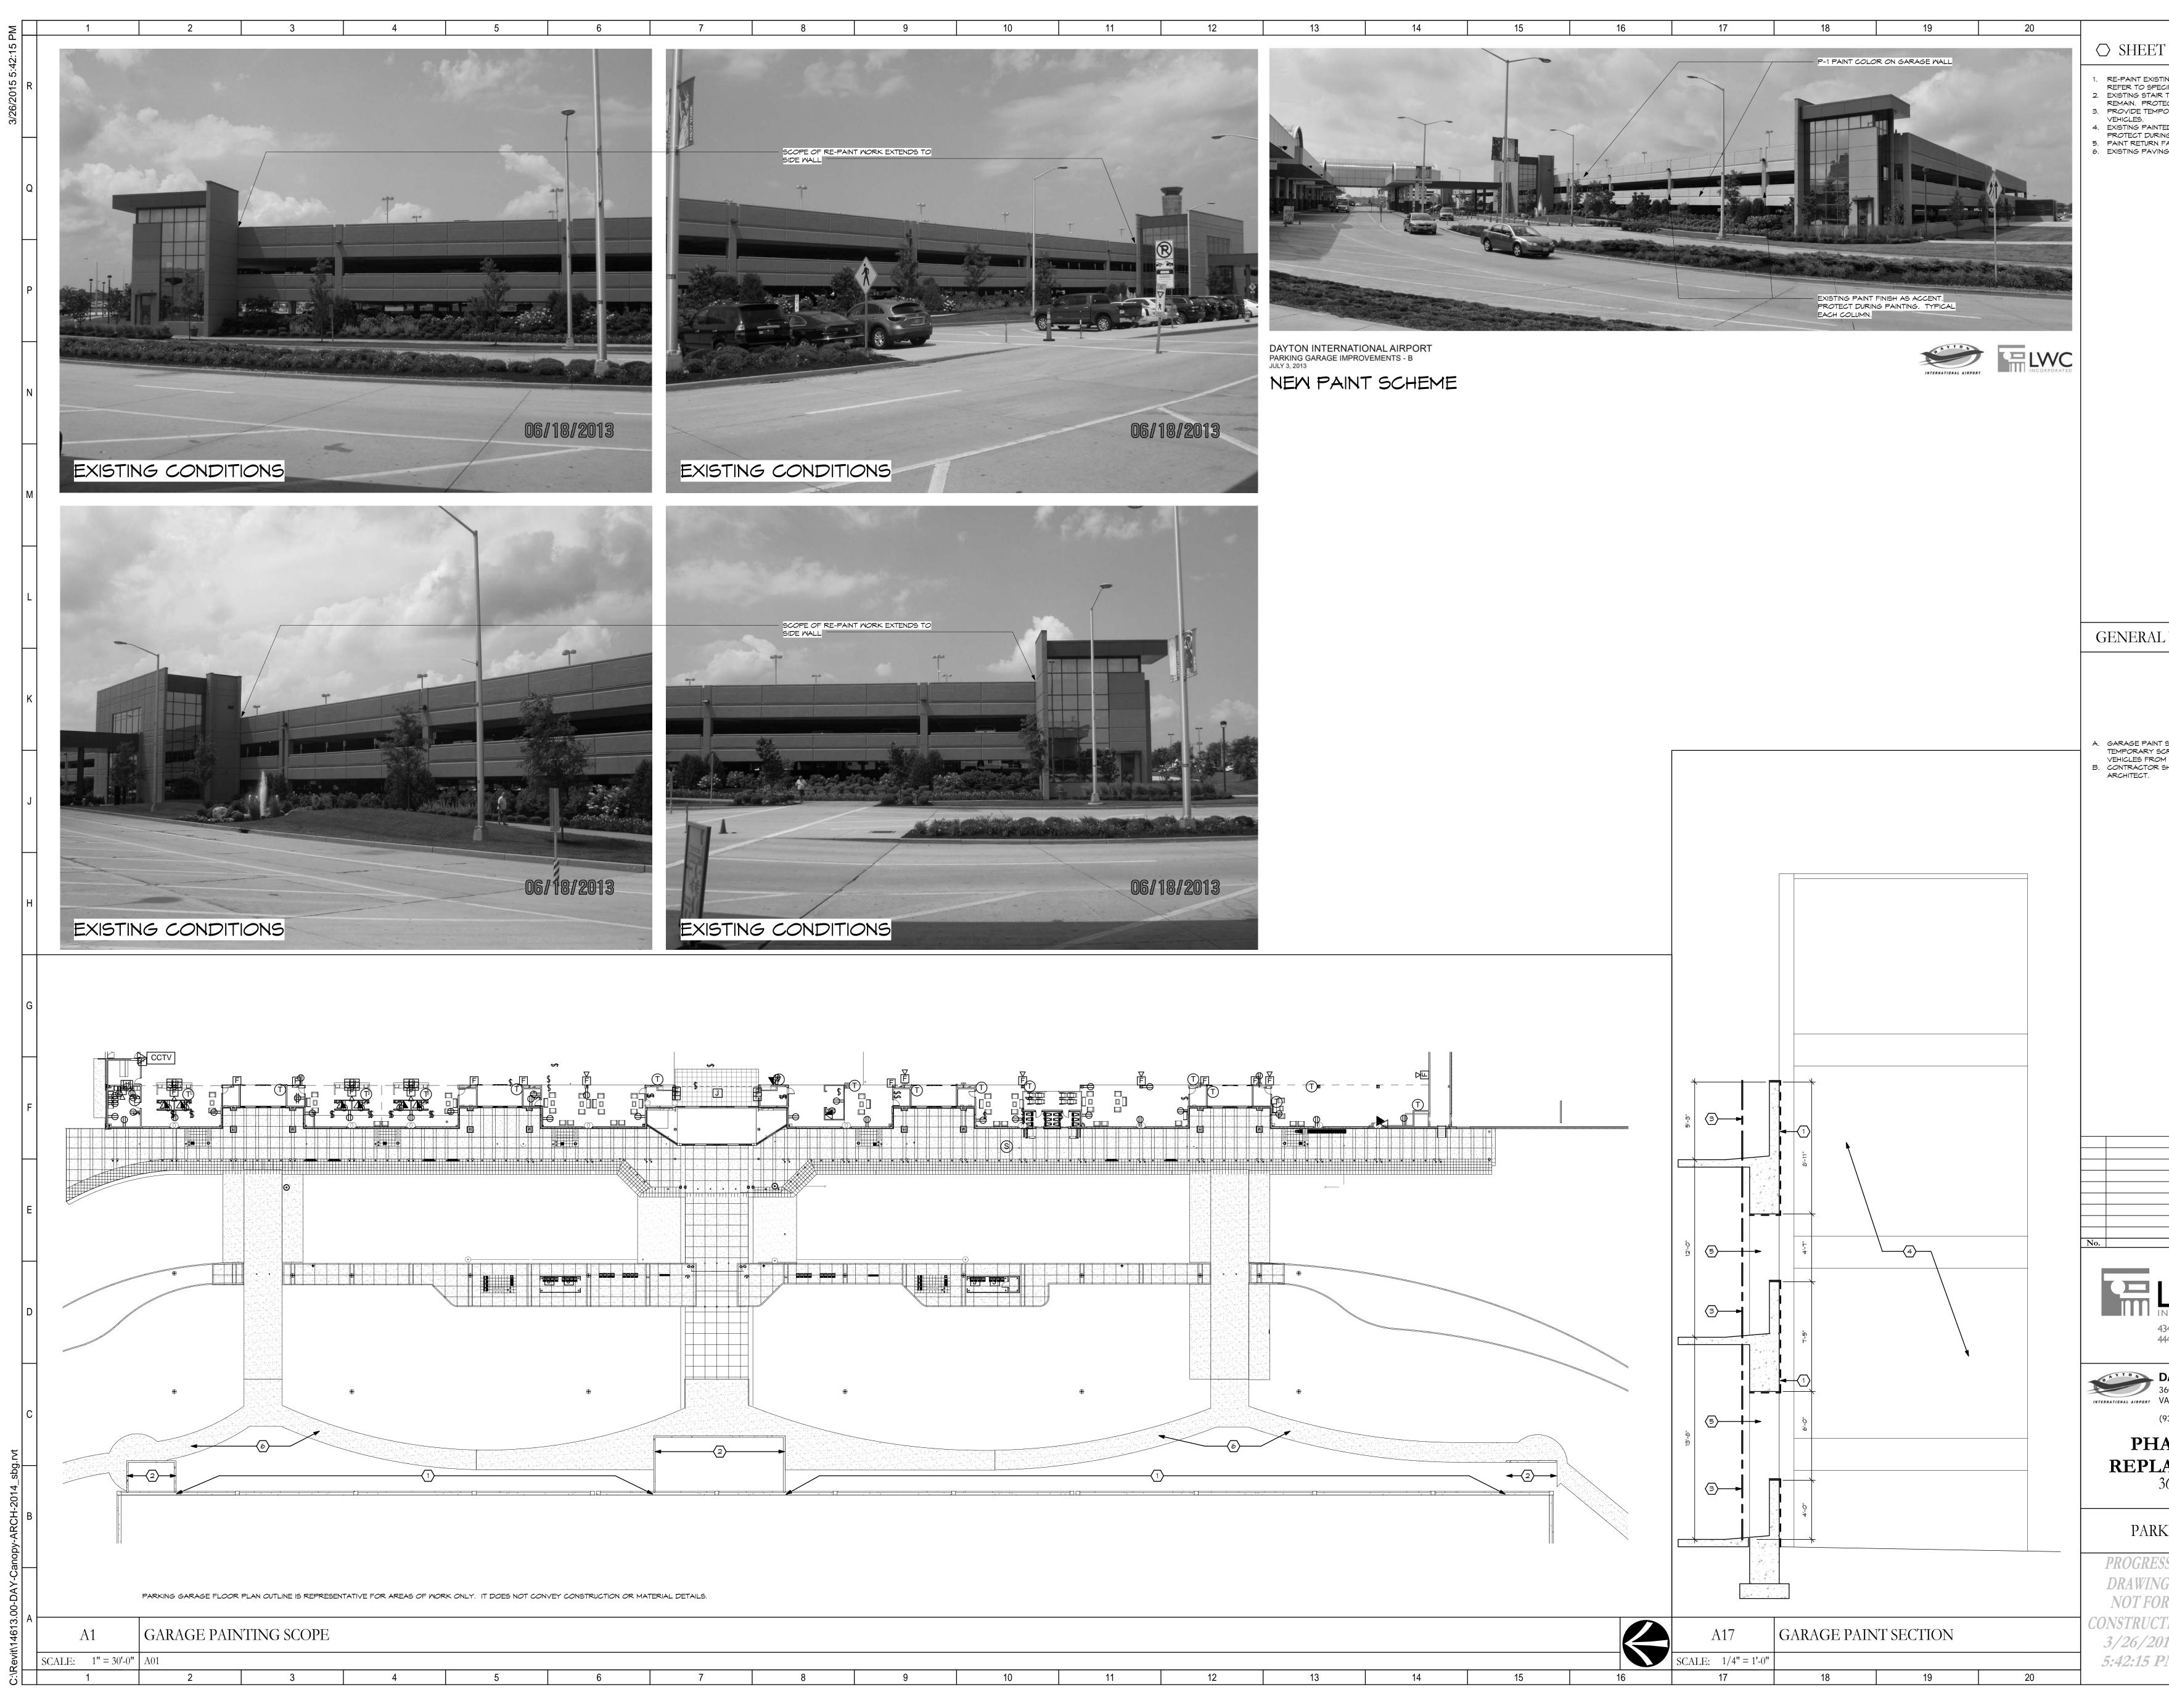


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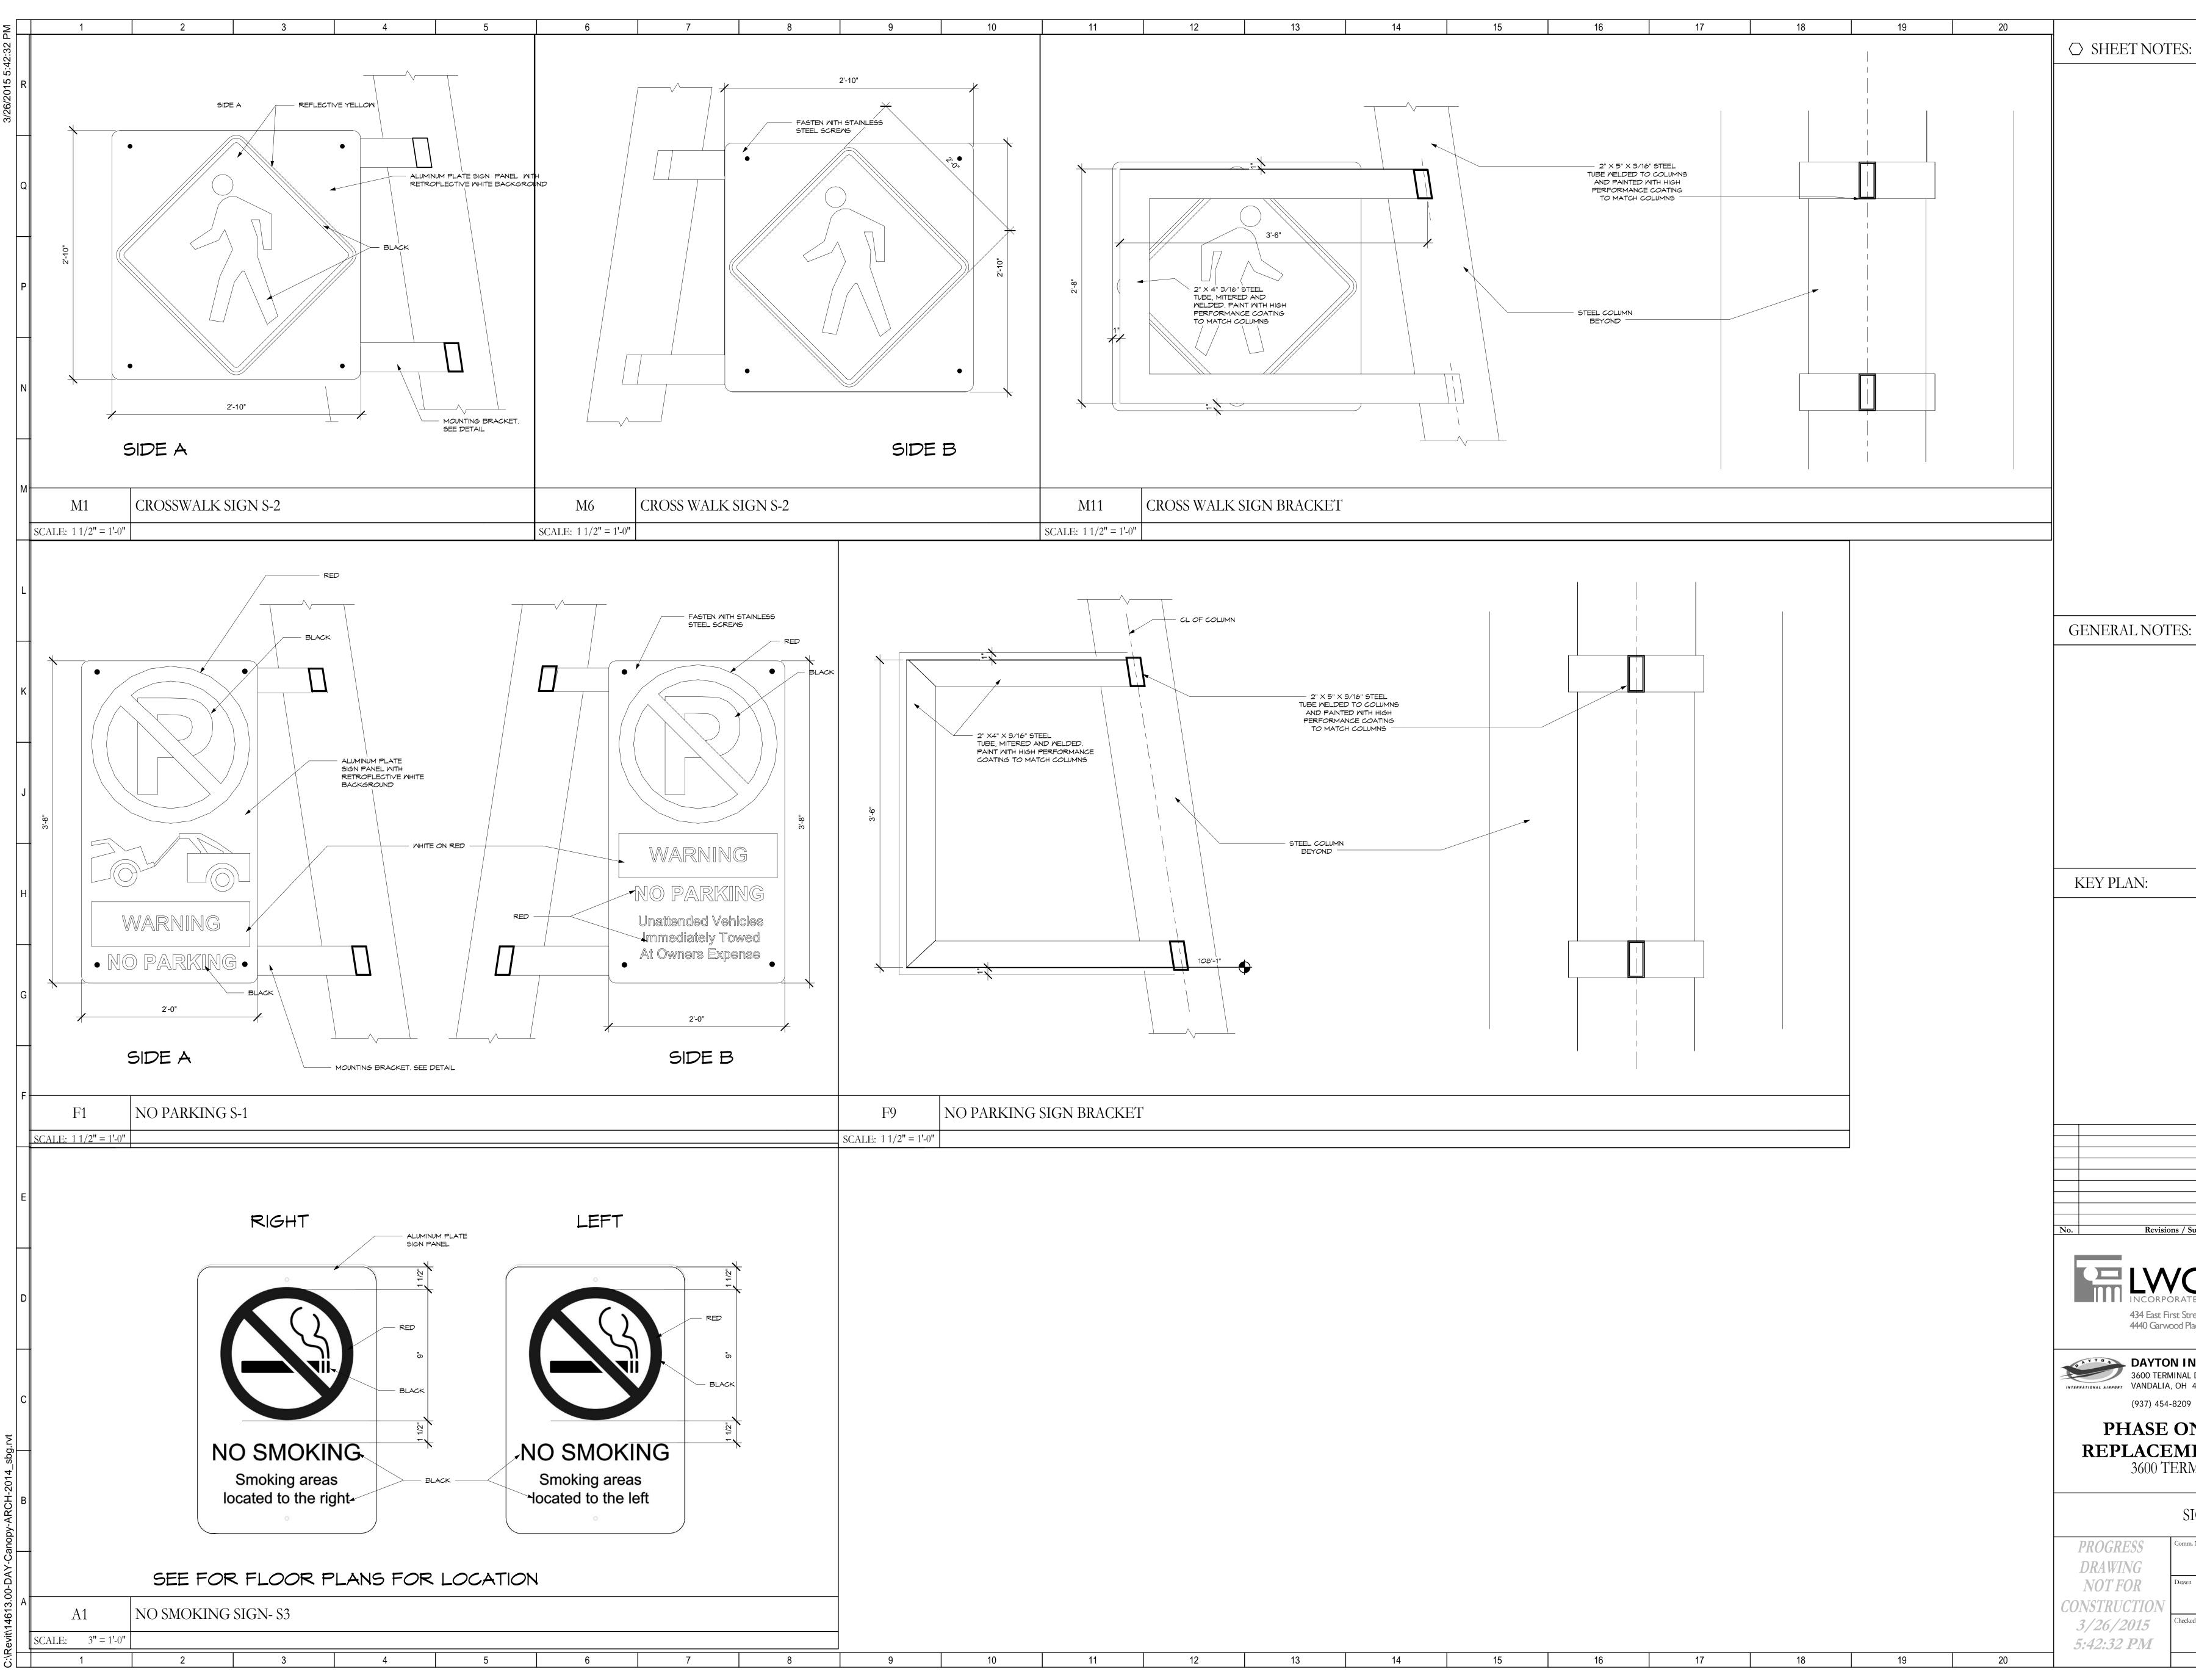


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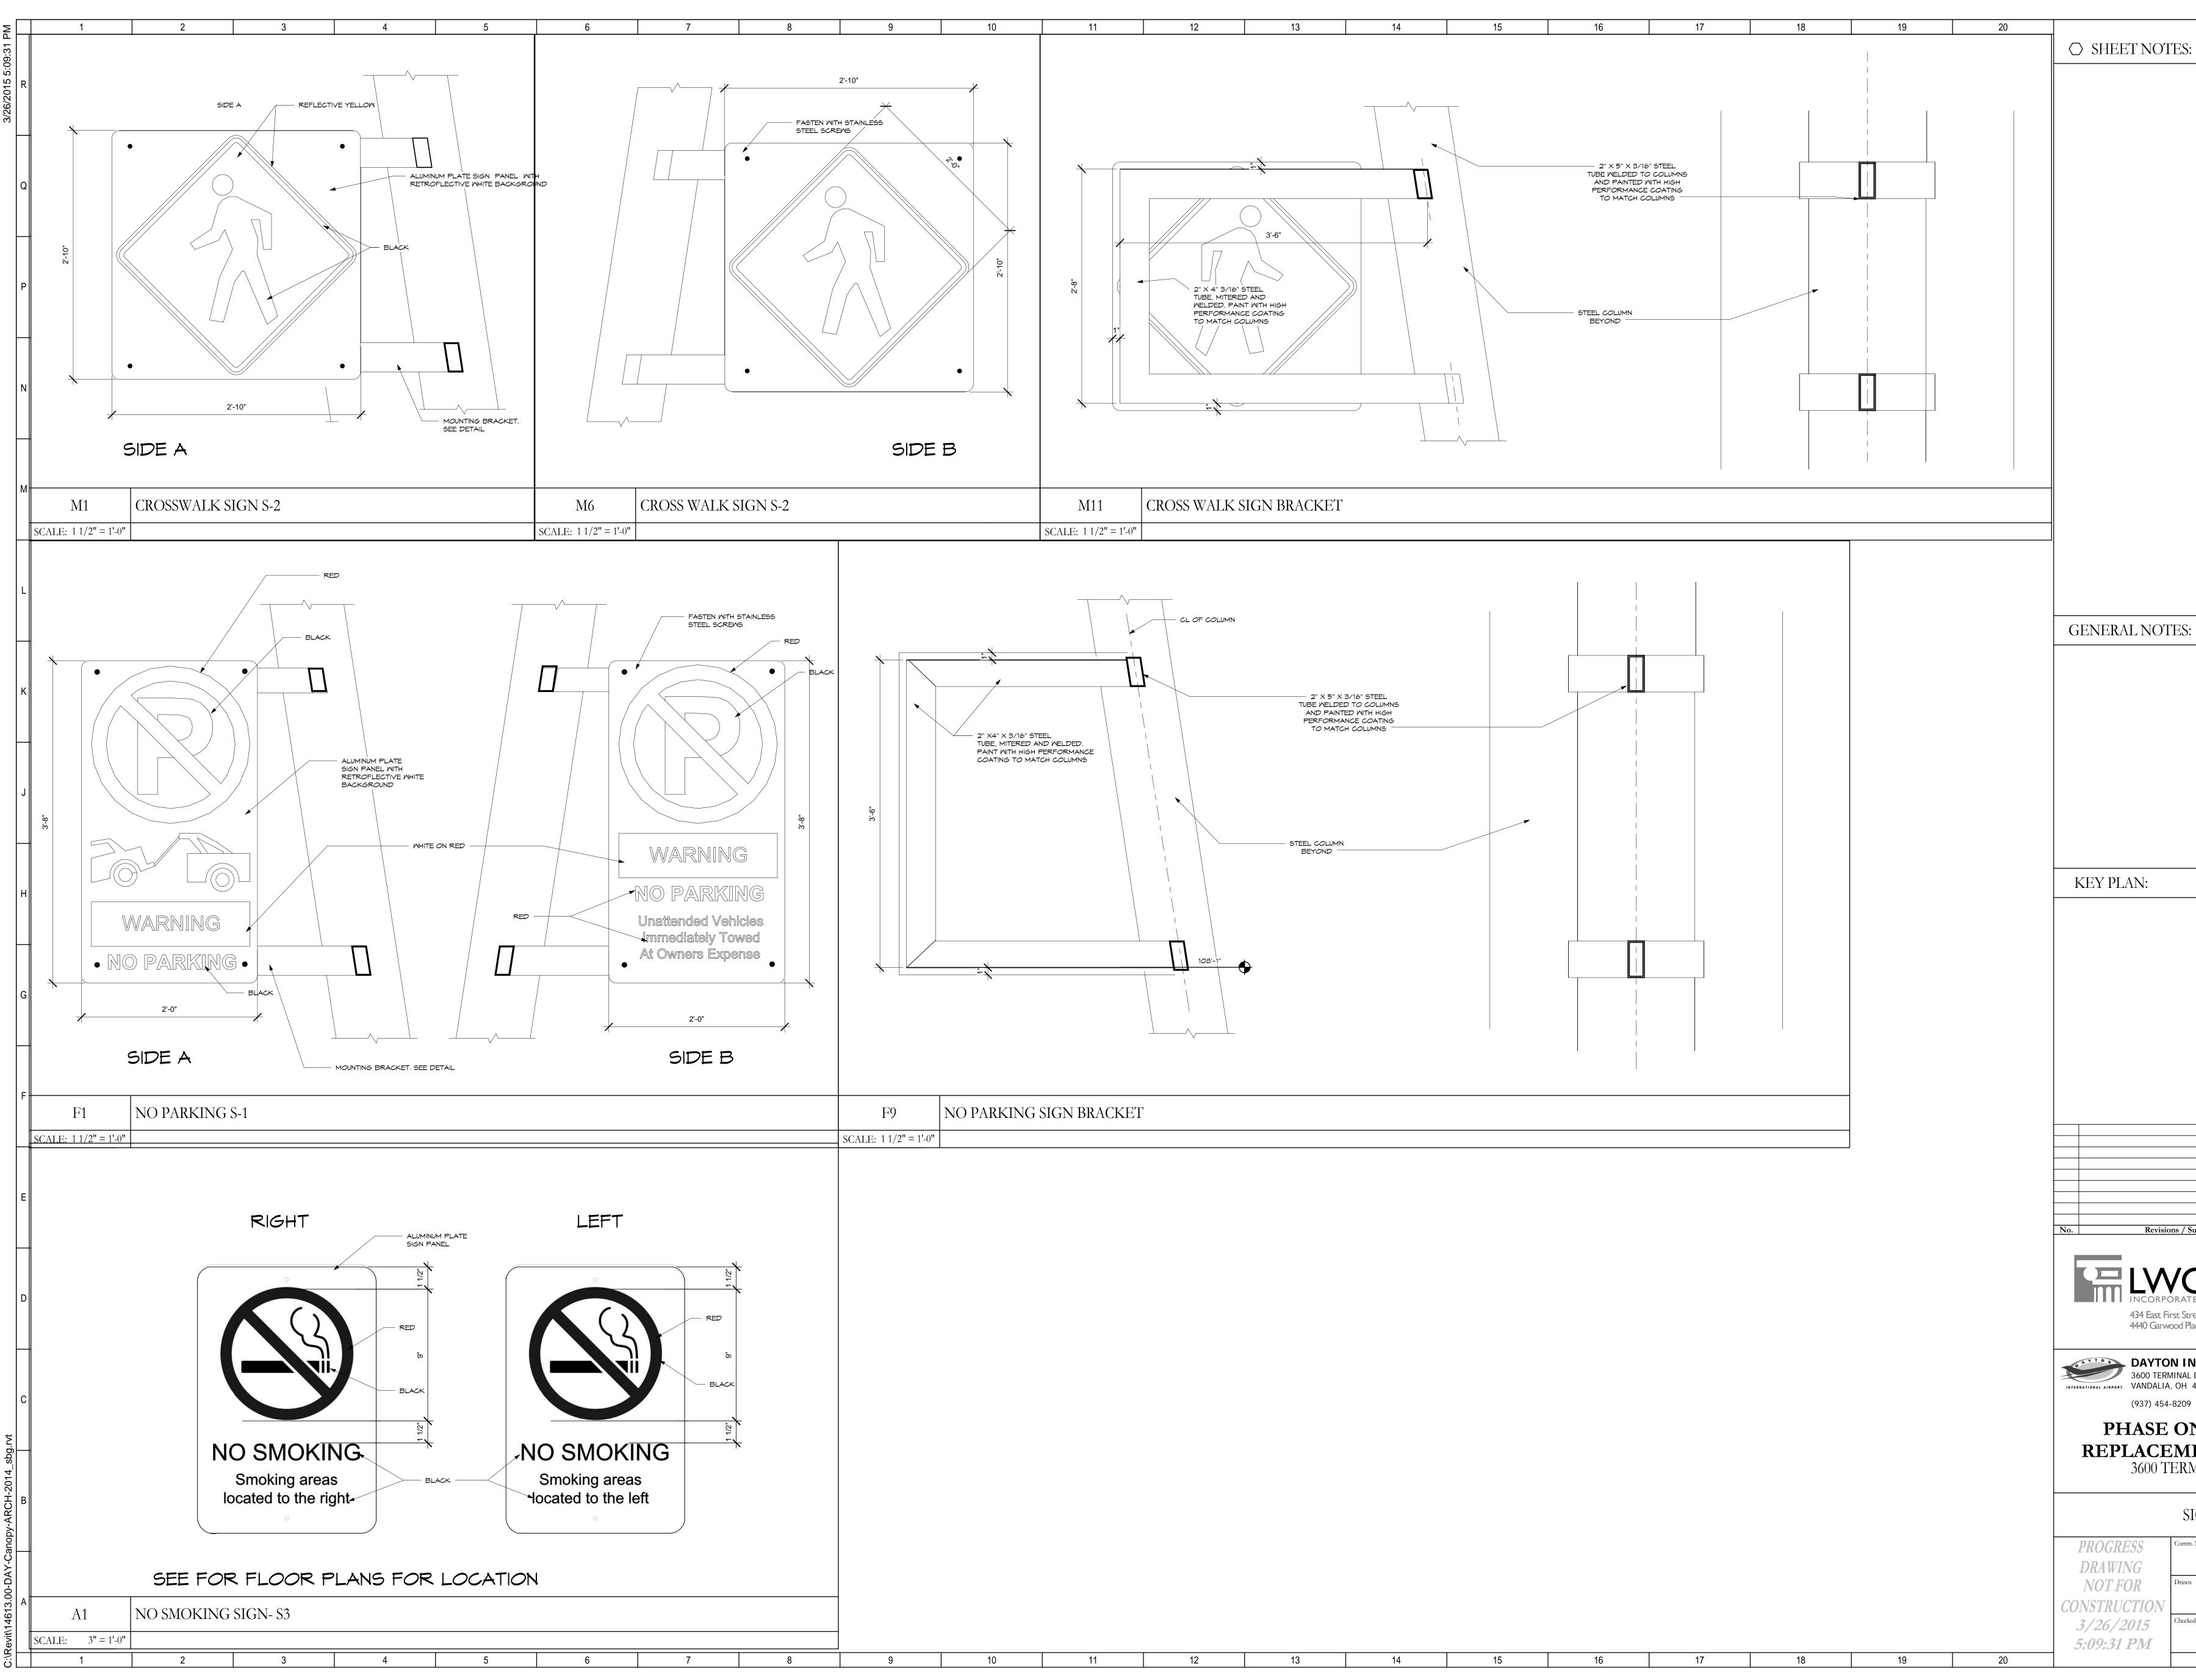
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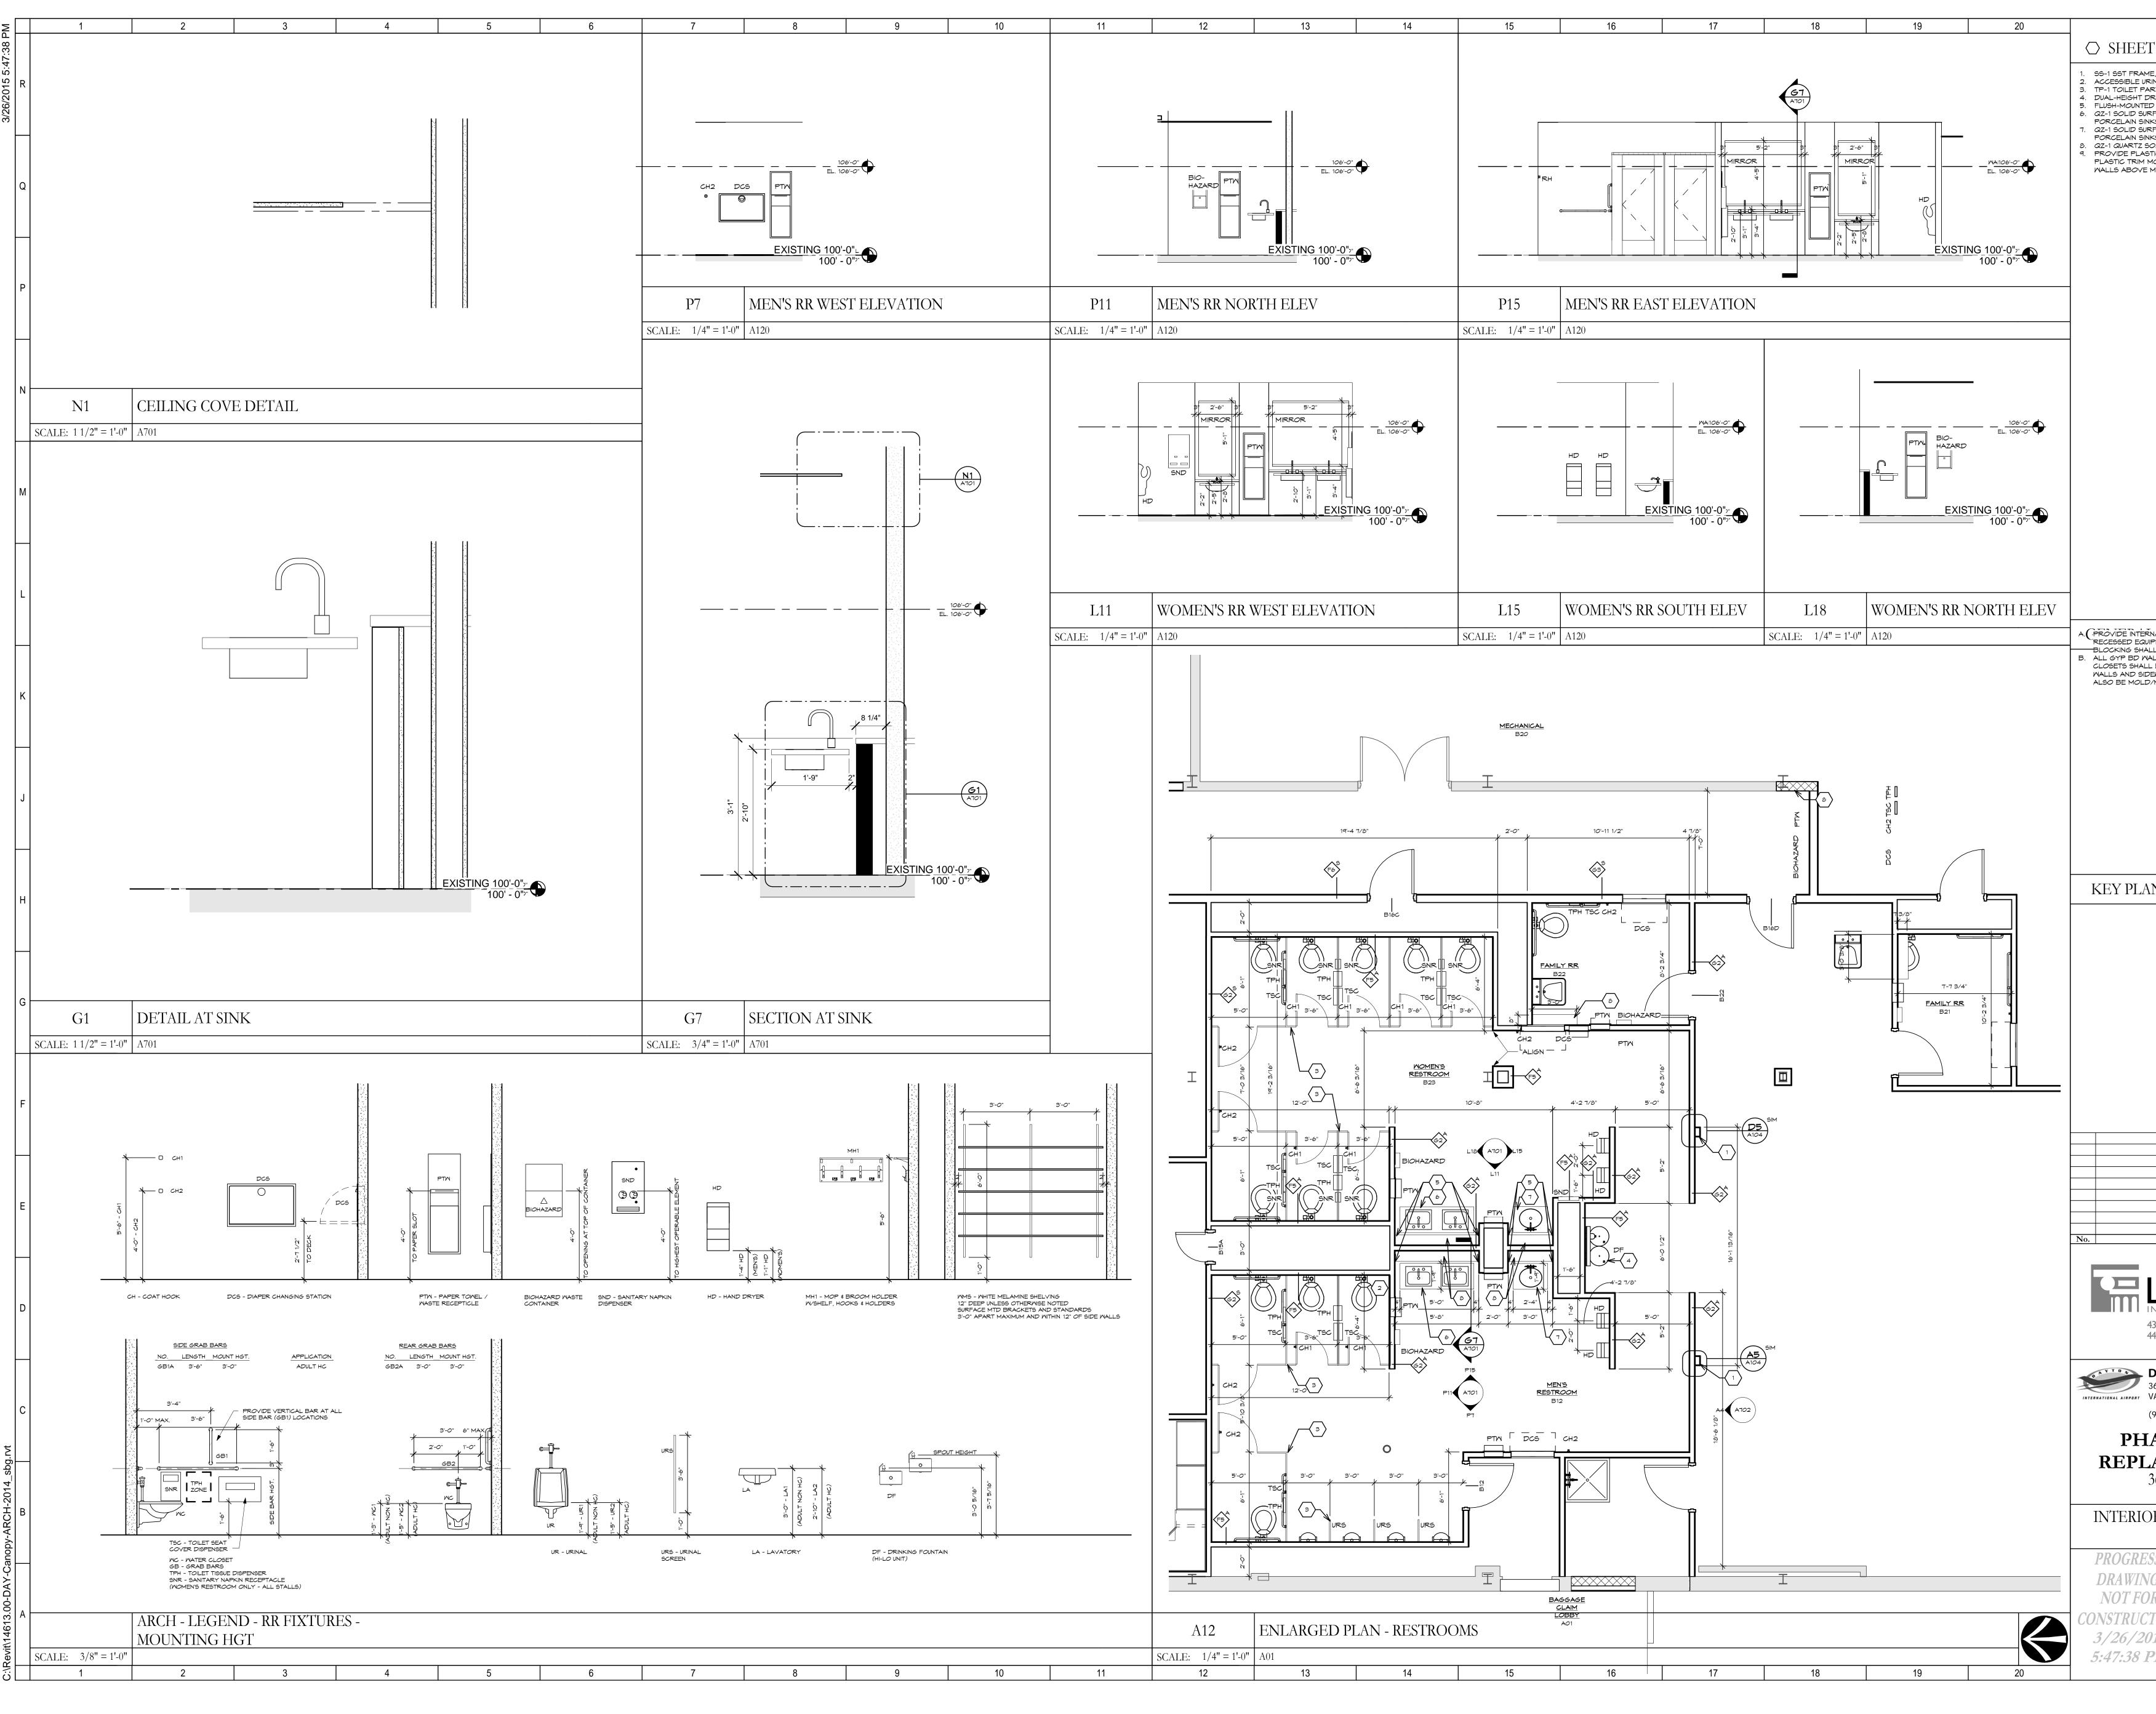
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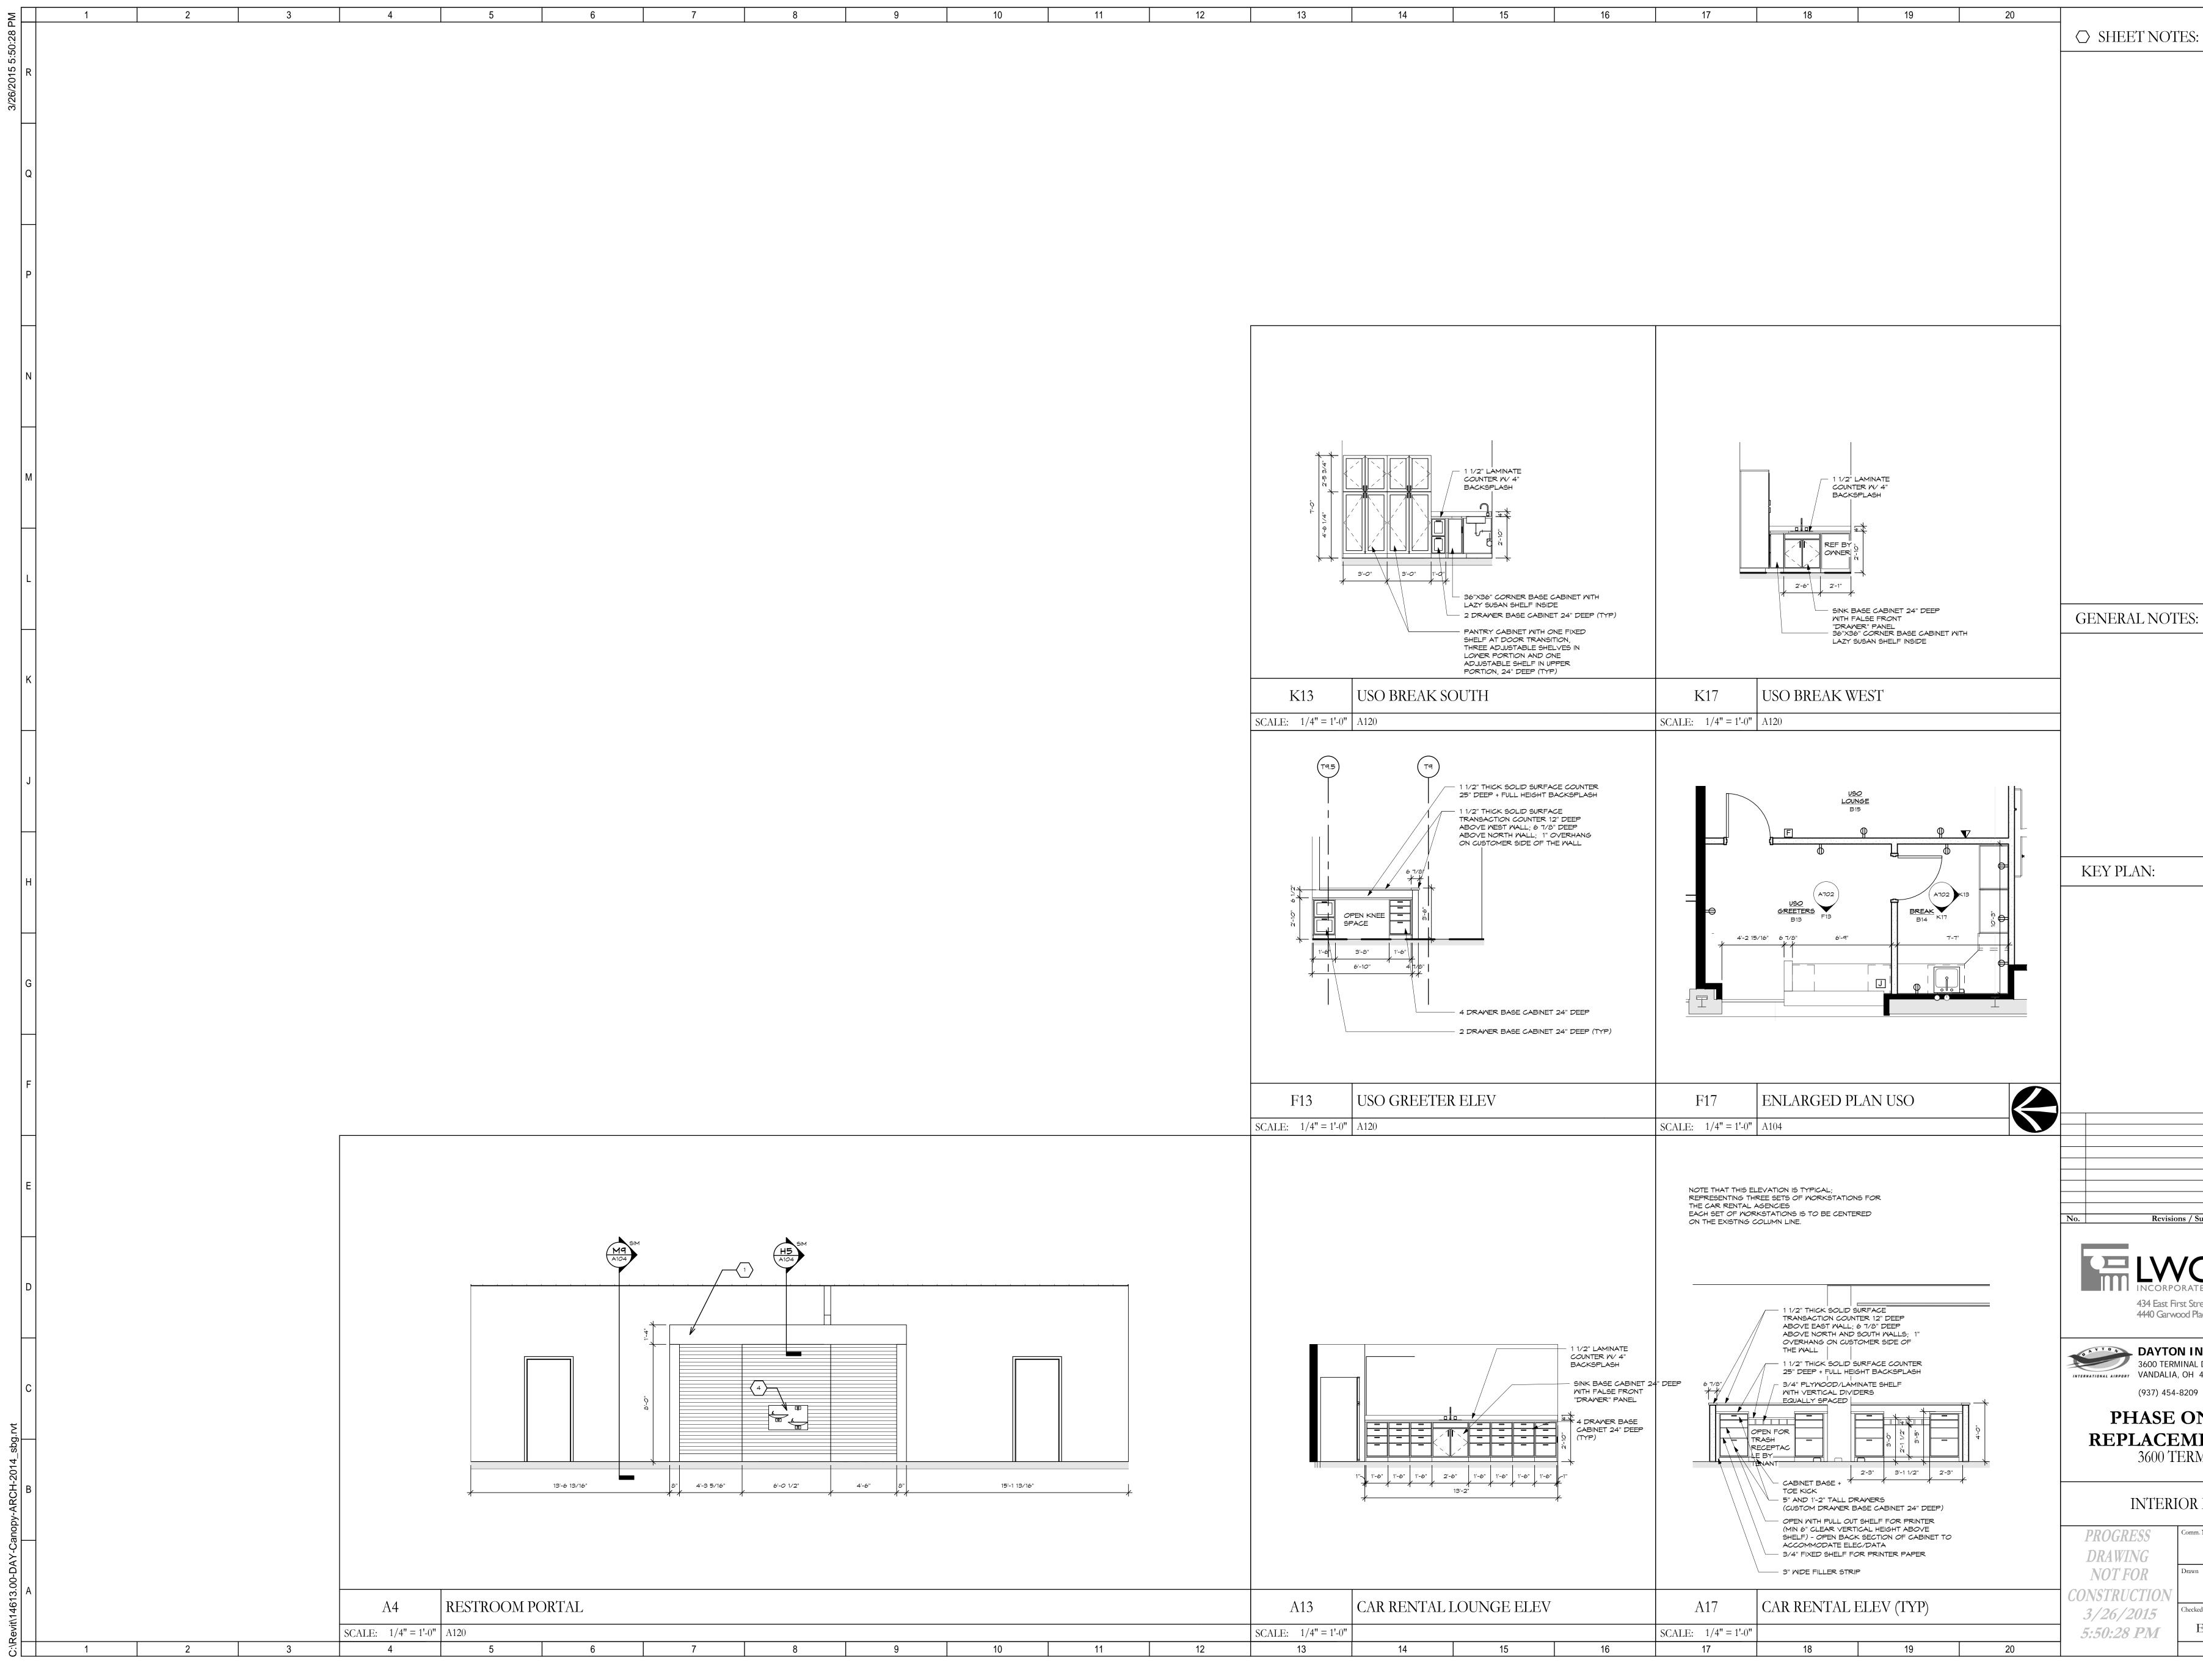
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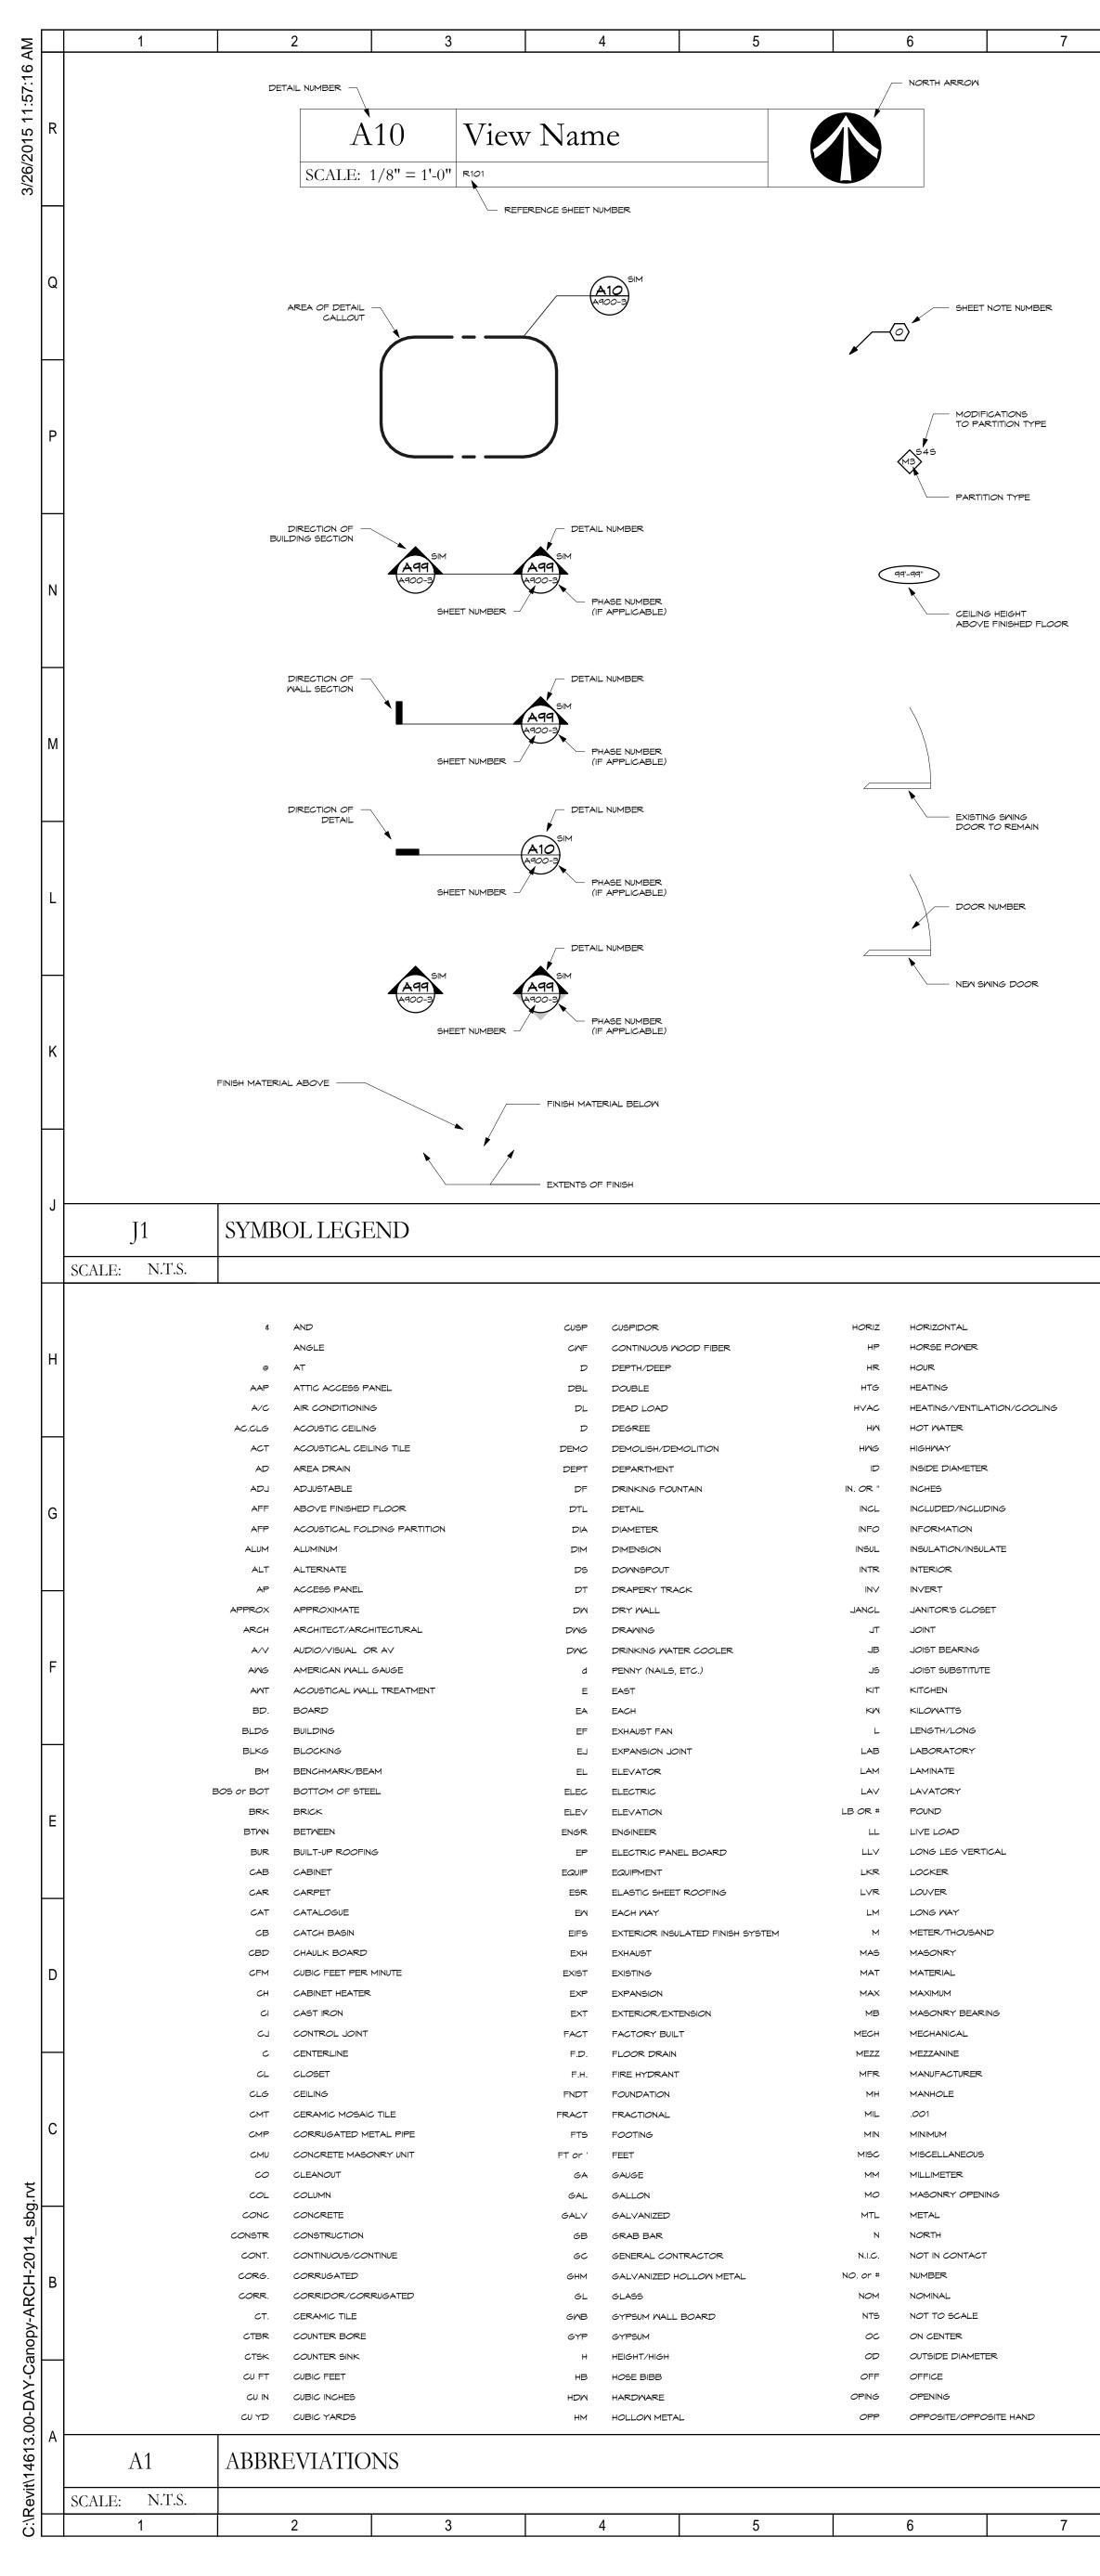
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ARTITION AND URINAL SCRE DRINKING FOUNTAINS WITH E D WALL SCONCE.	
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RFACE QUARTZ COUNTER M NKS (SEE TYPICAL CROSS S	NITH UNDER-MOUNTED SECTION FOR CHILD SINK)
SOLID SURFACE COUNTER C STIC WALL PROTECTION 48	" HIGH WITH SEALANT AND
MOLDING ALONG ALL EDG MOP SINK.	ES AND JOINTS ALONG BOTH
	RE SURFACE-MOUNTED OR THING GYP BD WALLS. ALL REATED MATERIAL.
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L BE MOLD/MILDEN/MOIST DEWALLS ADJACENT TO DR D/MILDEW/MOISTURE RESIST	RINKING FOUNTAIN SHALL
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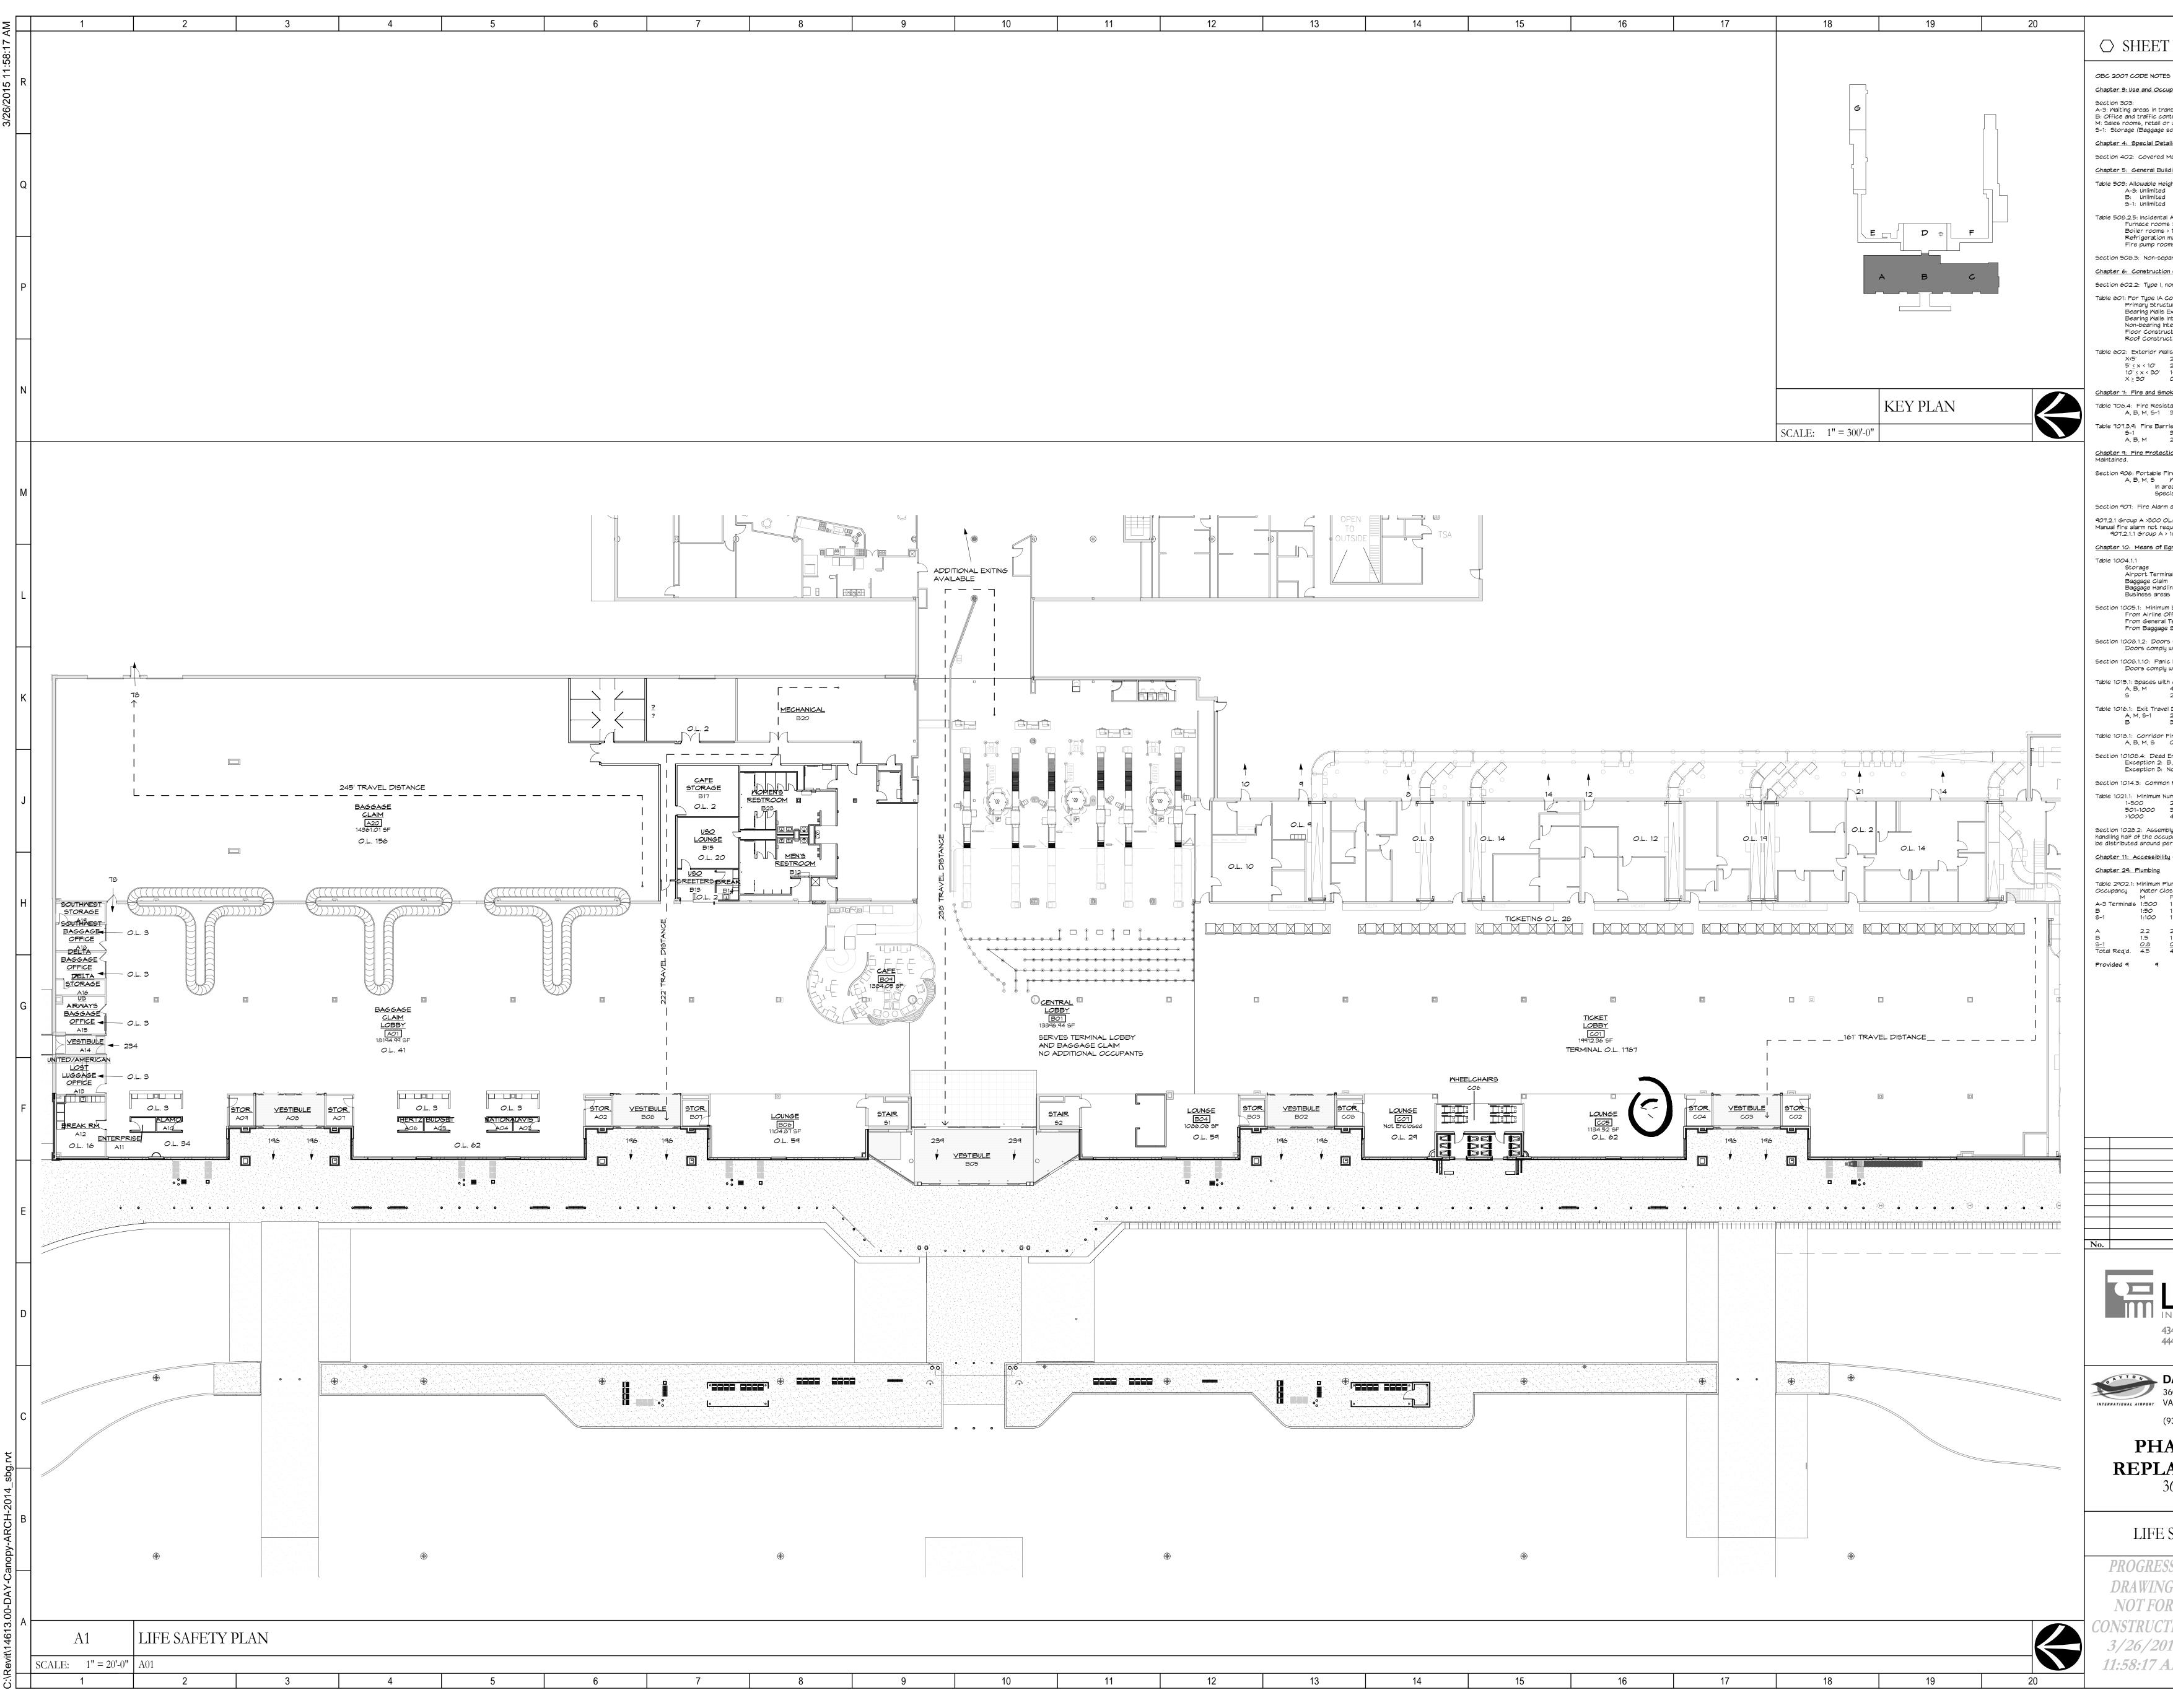
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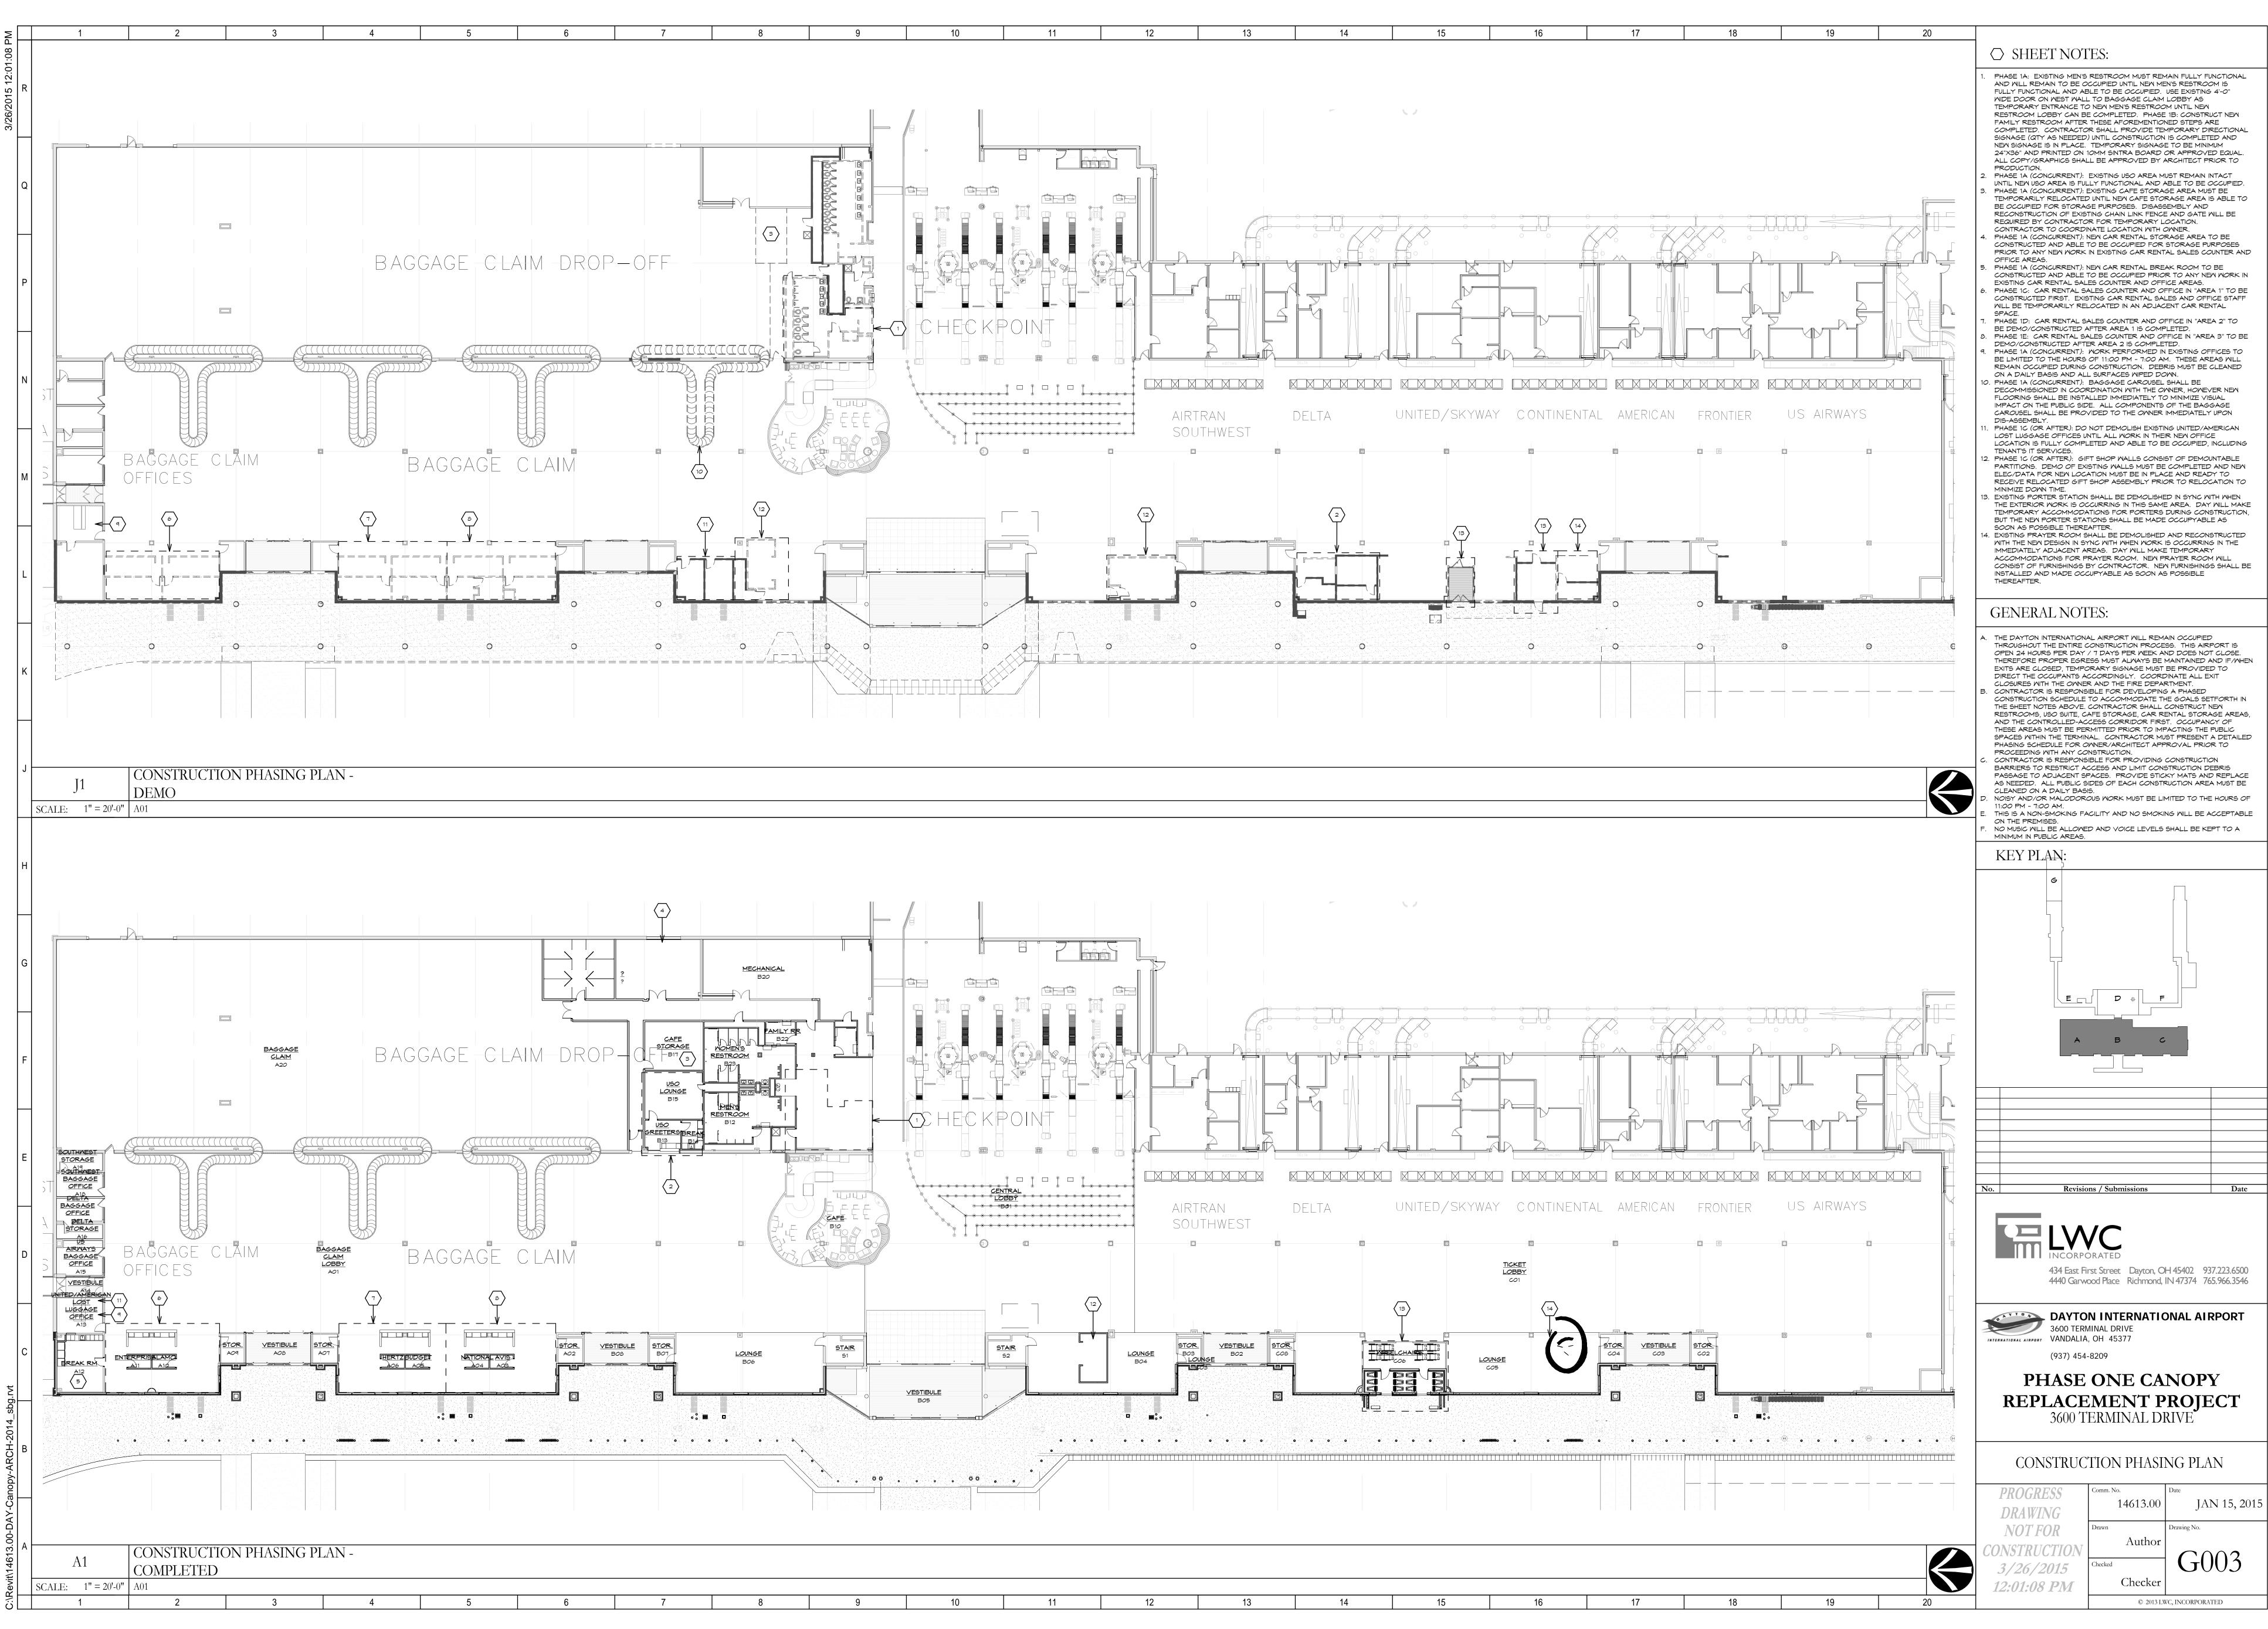
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NG	PL P	PLATE PROPERTY LINE		TOILET ACCESSORY(IES) TACK BOARD
	PLAS ASLAM	PLASTER PLASTIC LAMINATE		TELEPHONE TERRAZZO
F	PLBG	PLUMBING	T∉ B	TOP ∉ BOTTOM
	PLYMD REFAB	PLYWOOD PREFABRICATED		TONGUE & GROOVE TOP OF CONCRETE
Ŧ	PRVT PS	PRIVATE PROJECTION SCREEN		TOP OF FOOTING
	PSF	POUNDS PER SQUARE FOOT		TOP OF STEEL
	P51 P55	POUNDS PER SQUARE INCH PENCIL SHARPENER SUPPORT		TRANSFORMER TELEVISION
	PT PVC	PRESSURE TREATED POLYVINYL CHLORIDE		TACKABLE WALL SERVICE TYPICAL
	QT	QUARRY TILE	U.L.	UNDERWRITER'S LABORATORY
	RAD R	RADIUS RISER		UNLESS OTHERWISE NOTED URINAL
	RA RB	RETURN AIR RESILIENT BASE		UNIT VENTILATOR VERIFY IN FIELD
	RCP	REINFORCED CONCRETE PIPE	VERT	VERTICAL
f	RD RCPT	ROOF DRAIN RECEPTACLE		VINYL COMPOSITION TILE VINYL COVERED GYPSUM WALLBOARD
	RENF REF	REINFORCED/REINFORCEMENT REFERENCE		VITREOUS VOLUME
	REFR	REFRIGERATOR	VRB	VENTED RESILIENT BASE
	REQ'D RE V	REQUIRED REVISION(S)		VAPOR RETARDER VENT STACK
	RM RO	ROOM ROUGH OPENING		VERSUS VINYL TILE
ROW or	or R/W	RIGHT OF WAY	VTR	VENT THROUGH ROOF
	S SA	SOUTH SUPPLY AIR		WEST
	SAC SCH	SUSPENDED ACOUSTICAL CEILING SCHEDULE		WARDROBE ACCESSORIES WOOD BASE
e	SCWD	SOLID CORE WOOD	WC	WATER CLOSET
	SD SECT	STORM DRAIN SECTION		WIND COLUMN WOOD
SF or s	SQFT SGFT	SQUARE FEET STRUCTURAL GLAZED FACING TILE		WATER HEATER WITHOUT
	SHT SIM	SHEET SIMILAR	MP	WORKING POINT WATER RESISTANT
	SLV	SHORT LEG VERTICAL	WSSK	WALL SERVICE SINK
	PEC(S) SPKR	SPECIFICATION(S) SPEAKER		WELDED WIRE FABRIC WOVEN WIRE MESH
		SQUARE STAINLESS STEEL	YD	YARD/YARD DRAIN
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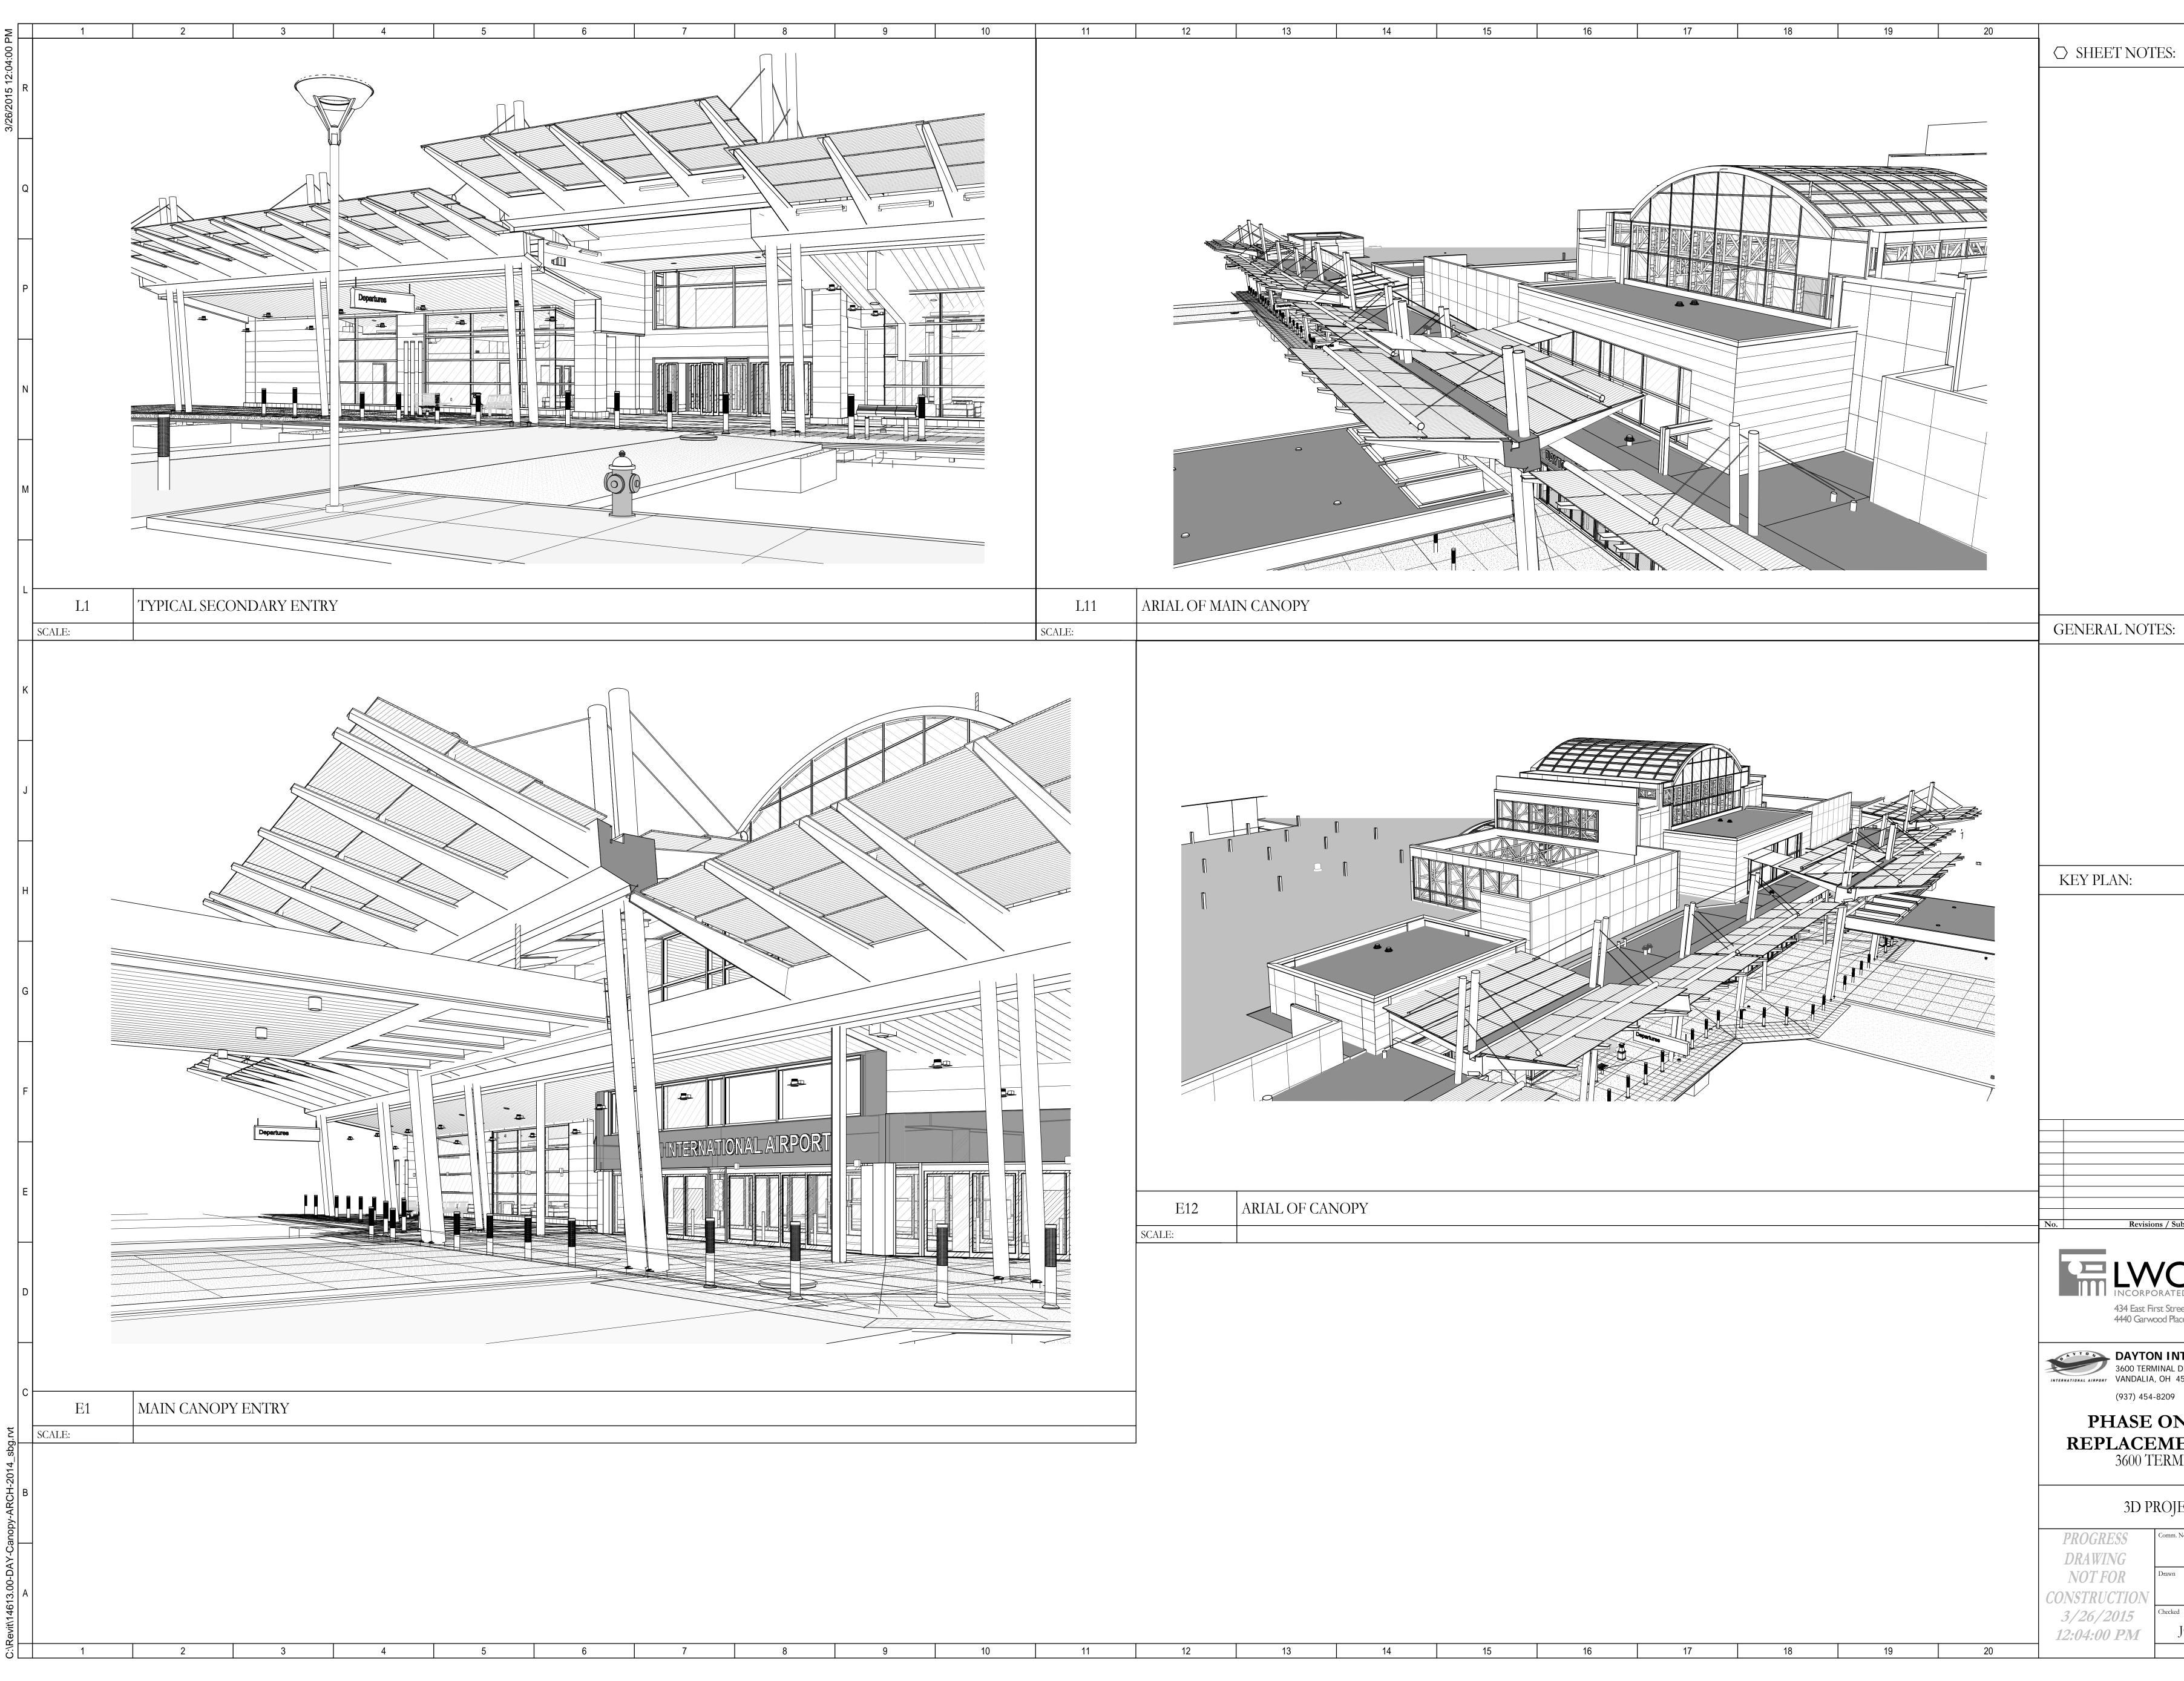
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TNOTES:					
S upancy Classification					
nsportation terminals ntrol towers					
r wholesale stores sorting) ailed Requirements for Use and Occupancy					
Mall – Does not meet requirements for covered mall. Iding Heights and Areas					
ights and Areas for Type IA construction					
I Accessory Occupancies s > 400,000 btu 1-hour or sprinkler > 15 psi or 10 hp 1-hour or sprinkler machine rooms > 1-hour or sprinkler oms > 2-hour or 1-hour with sprinkler					
parated mixed use: Most restrictive applies which is A on Classification	-3				
non-combustible Construction					
Exterior 3-hour Interior 3-hour, 2-hour if o Iterior partitions 0	nly supporting roof nly supporting roof				
Iction and Secondary Members 2-hour ction and Secondary Members 1.5-hours Ills for Type IA Construction					
2-hour for M & S, 1-hour for A & B 2-hour for M & S, 1-hour for A & B 1-hour for A, B, M, & S 0					
oke Protection Stance of Fire Walls for Type IA Construction					
3-hour riers 3-hour					
2-hour <mark>tion Systems:</mark> Full Automatic Sprinkler System Exists a	nd will be				
Fire Extinguishers Within 30' of commercial cooking equipment reas of flammable or combustible liquids storage, use, c	or dispensing				
cial hazards as determined by the Building Official n and Detection	שייי ,				
DL: Manual fire alarm system that actives occupant not quired with alarm activated by flow of sprinkler. • 1000 OL: Alarm must include a voice/alarm communic	2				
Egress 300 gross/occupant					
nal 20 gross/occupant 1 300 gross/occupant Iling 100 gross/occupant					
is 100 gross/occupant n Exit width - OL x .3" for stairs and OL x .2" for othe Offices: 88 OL x .2" = 18" required, 288" provided Terminal, 2280 OL x .2" = 456" required, 688" provide					
Terminal: 2280 OL x .2" = 456" required, 688" provide sorting Room: 78 OL x .2" = 16" required, 36" provide rs swing in direction of egress with OL \ge 50					
with swing or 1008.1.4.3 for horizontal sliding doors ic hardware for A occupancies with OL <u>></u> 50 with 1008.1.4.3, horizontal sliding doors					
h one exit 49 OL 29 OL					
el Distance with Sprinkler 250' 300'					
Fire-Resistance Rating with Sprinkler O					
Ends 20' maximum B, M, S 50' max. Not limited when length is 2.5 times minimum width.					
n Path of Egress Travel: 75' Iumber of Exits					
2 exits 3 exits 4 exits					
bly Main Exit – When OL exceeds 300, must have a mair upant load. Exception: Where no well-defined main entr erimeter	ance, the exits may				
<u>y</u> – Meeting ICC 117.1 and 2010 Accessibility Standards	of the ADA				
'lumbing Fixtures osets Lavatories Drinking Fnt. Ser F M F 1:500 1:750 1:750 1:1000	v. Sink 1				
osets Lavatories Drinking Fnt. Serv F M F 1:500 1:750 1:750 1:1000 1:50 1:80 1:80 1:100 1:100 1:100 1:100	1 1 1				
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DAYTON INTERNATIONAL AIRPORT 6600 TERMINAL DRIVE /ANDALIA, OH 45377				
937) 454-8209 ASE ONE CANOPY				
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